UBC BCR Lot 7

ISSUED FOR DEVELOPMENT PERMIT - JUNE 4, 2024

Landscape Drawing List

Cover Page Context Plan Tree Management Plan Landscape Plan Materials, Layout and Key Plan Exterior Lighting Plan

Grading Plan

Planting Plan

Illustrative Sections Illustrative Sections

Hardscape Details Furnishing and Planting Details

Precedent Images





Perry + Associates Landscape Architecture Site Planning 112 East Broadway Vancouver, BC V5T 1V9

T: 604.738.4118 perryandassociates.ca

2024-06-04

Description

Issued for Development Permit

COPYRIGHT RESERVED

This drawing is and shall remain the property of R. Kim Perry & Associates Inc., and R. Kim Perry & Associates Inc. shall retain the copyright therein. This document shall not be reproduced or used for additions or alterations to the project or for the purpose of any other project without the prior written consent of R. Kim Perry & Associates Inc.

Client:



UBC PROPERTIES TRUST


Project Title:

BC Research Lot 7 Residential Development

Drawing Title:

Cover Page

1:400 23-026 Sheet No.:

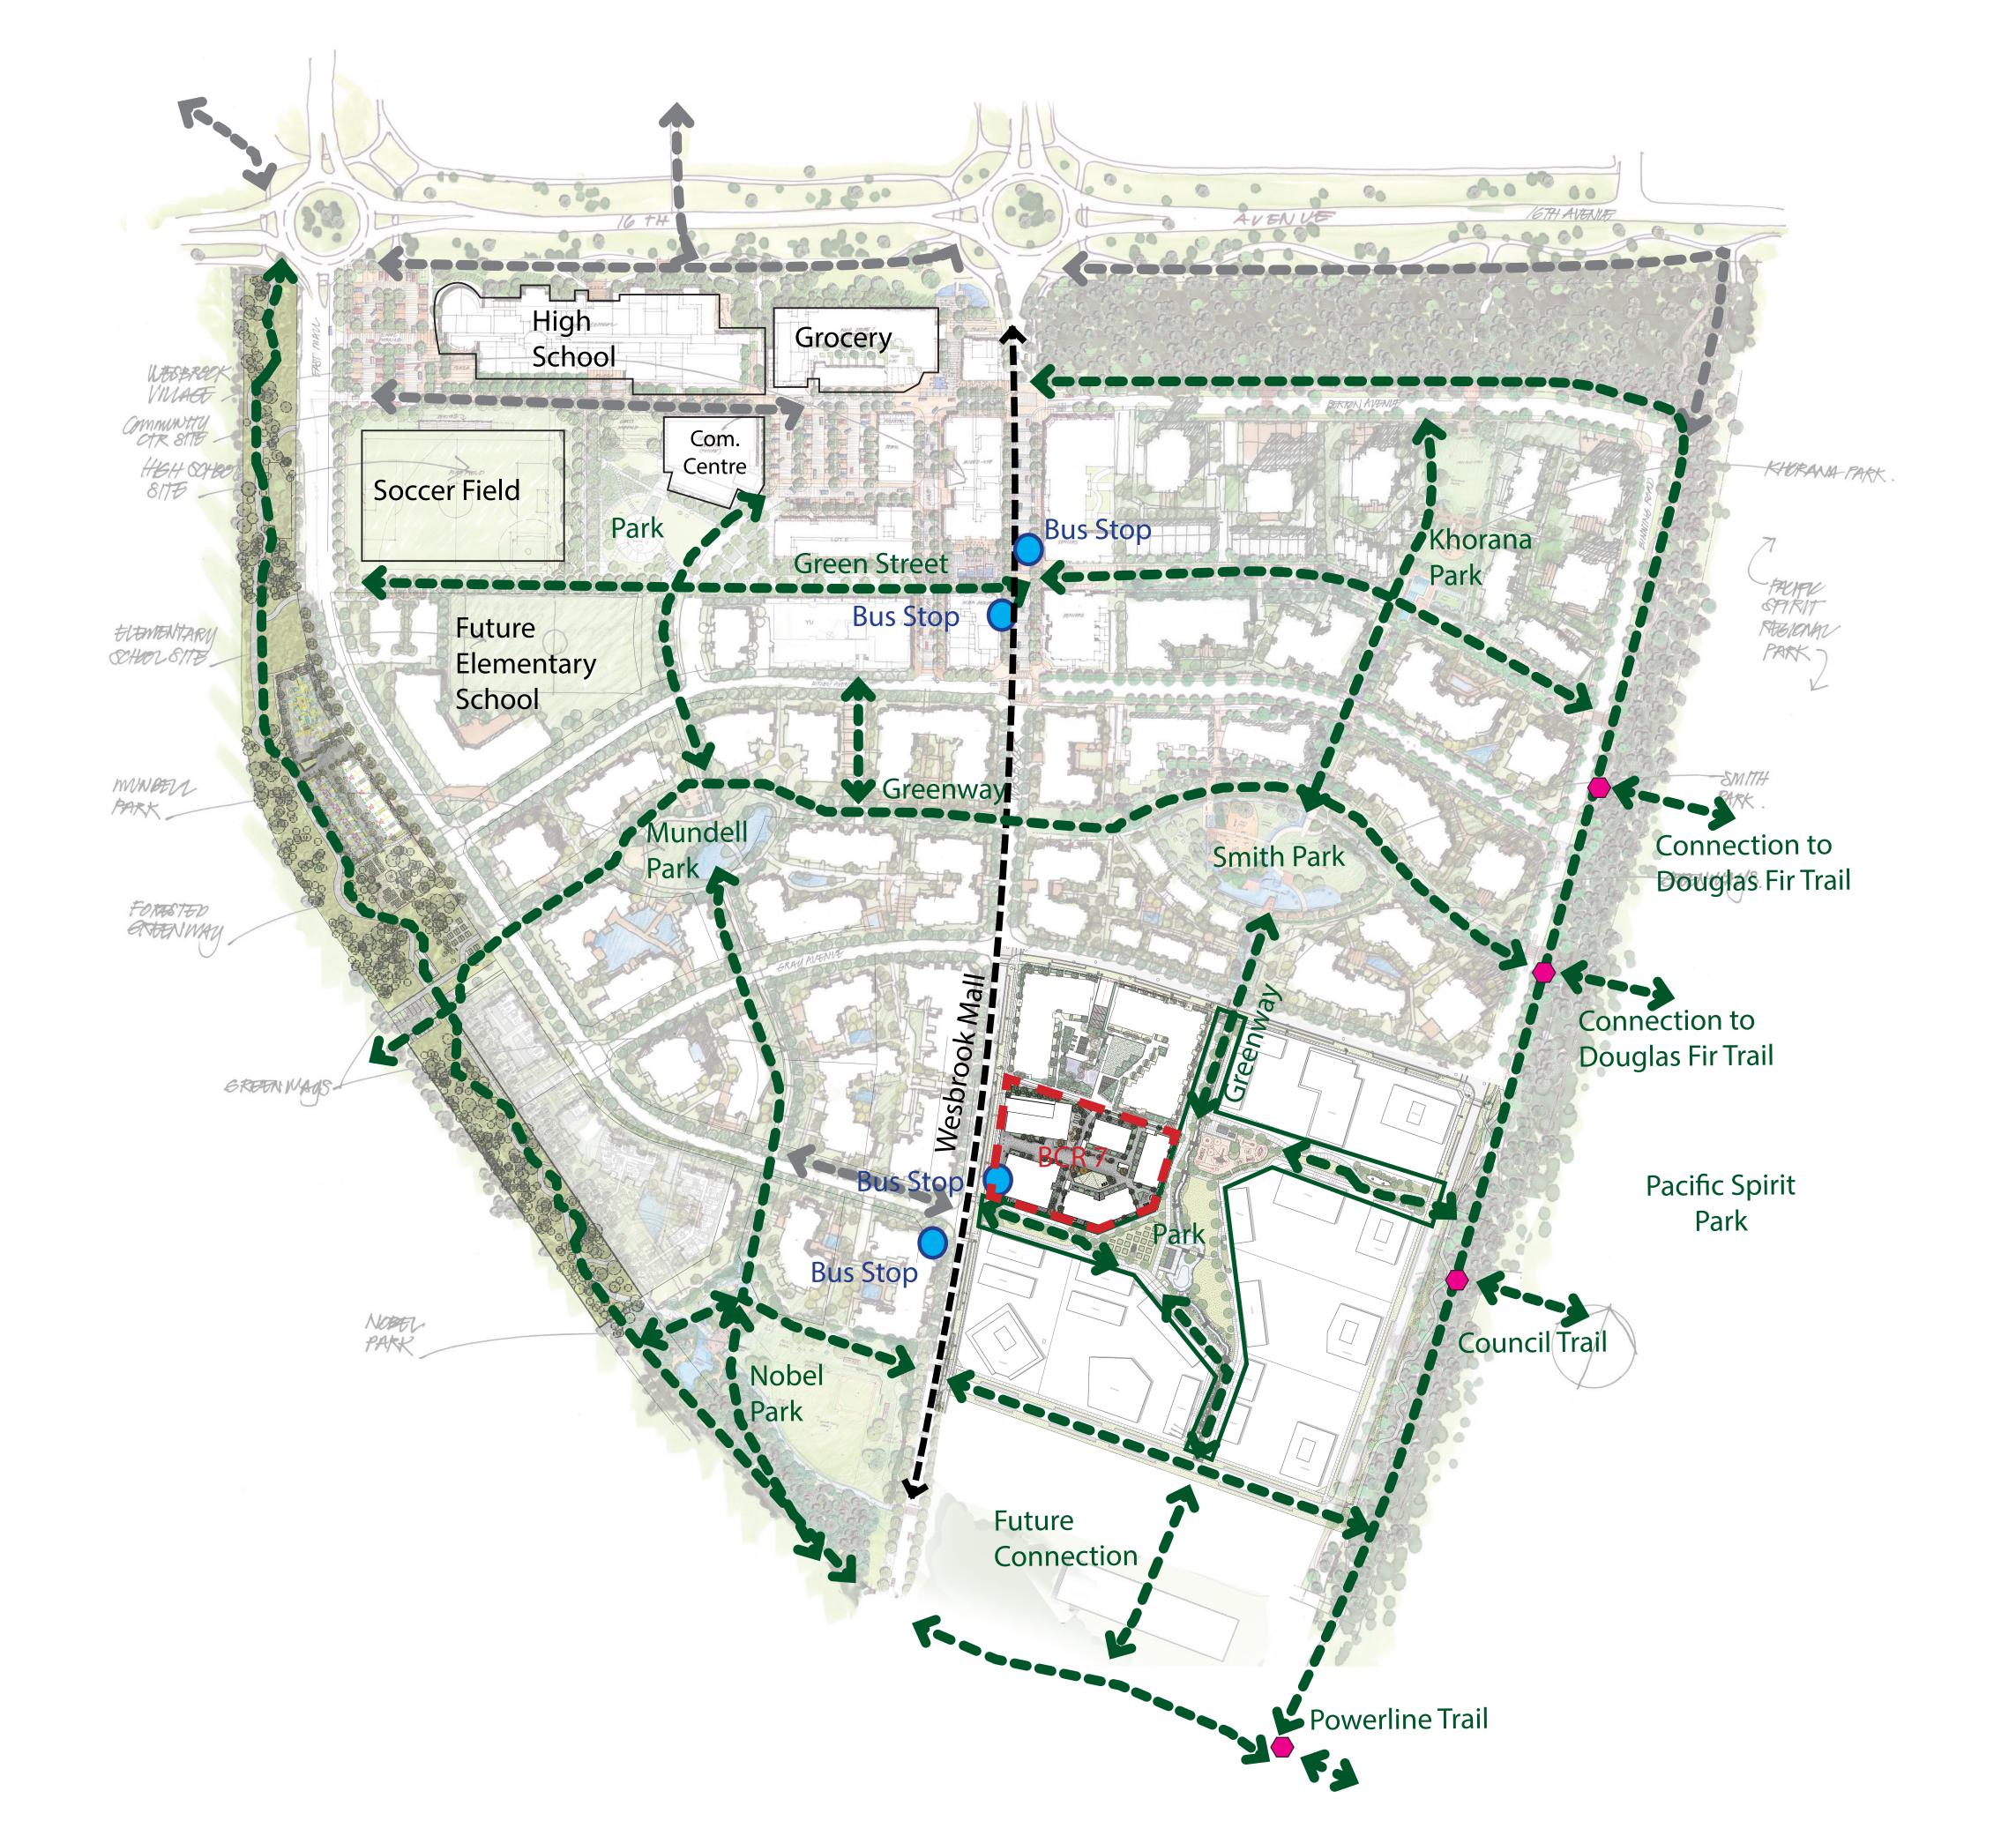



112 East Broadway Vancouver, BC V5T 1V9 T: 604.738.4118 perryandassociates.ca

2024-06-04

Description

Issued for Development Permit

COPYRIGHT RESERVED This drawing is and shall remain the property of R. Kim Perry & Associates Inc., and R. Kim Perry & Associates Inc. shall retain the copyright therein. This document shall not be reproduced or used for additions or alterations to the project or for the purpose of any other project without the prior written consent of R. Kim Perry & Associates Inc.

Client:



UBC PROPERTIES TRUST

Project Title:

BC Research Lot 7 Residential Development


Drawing Title:

Context Plan

NTS

Sheet No.:

23-026

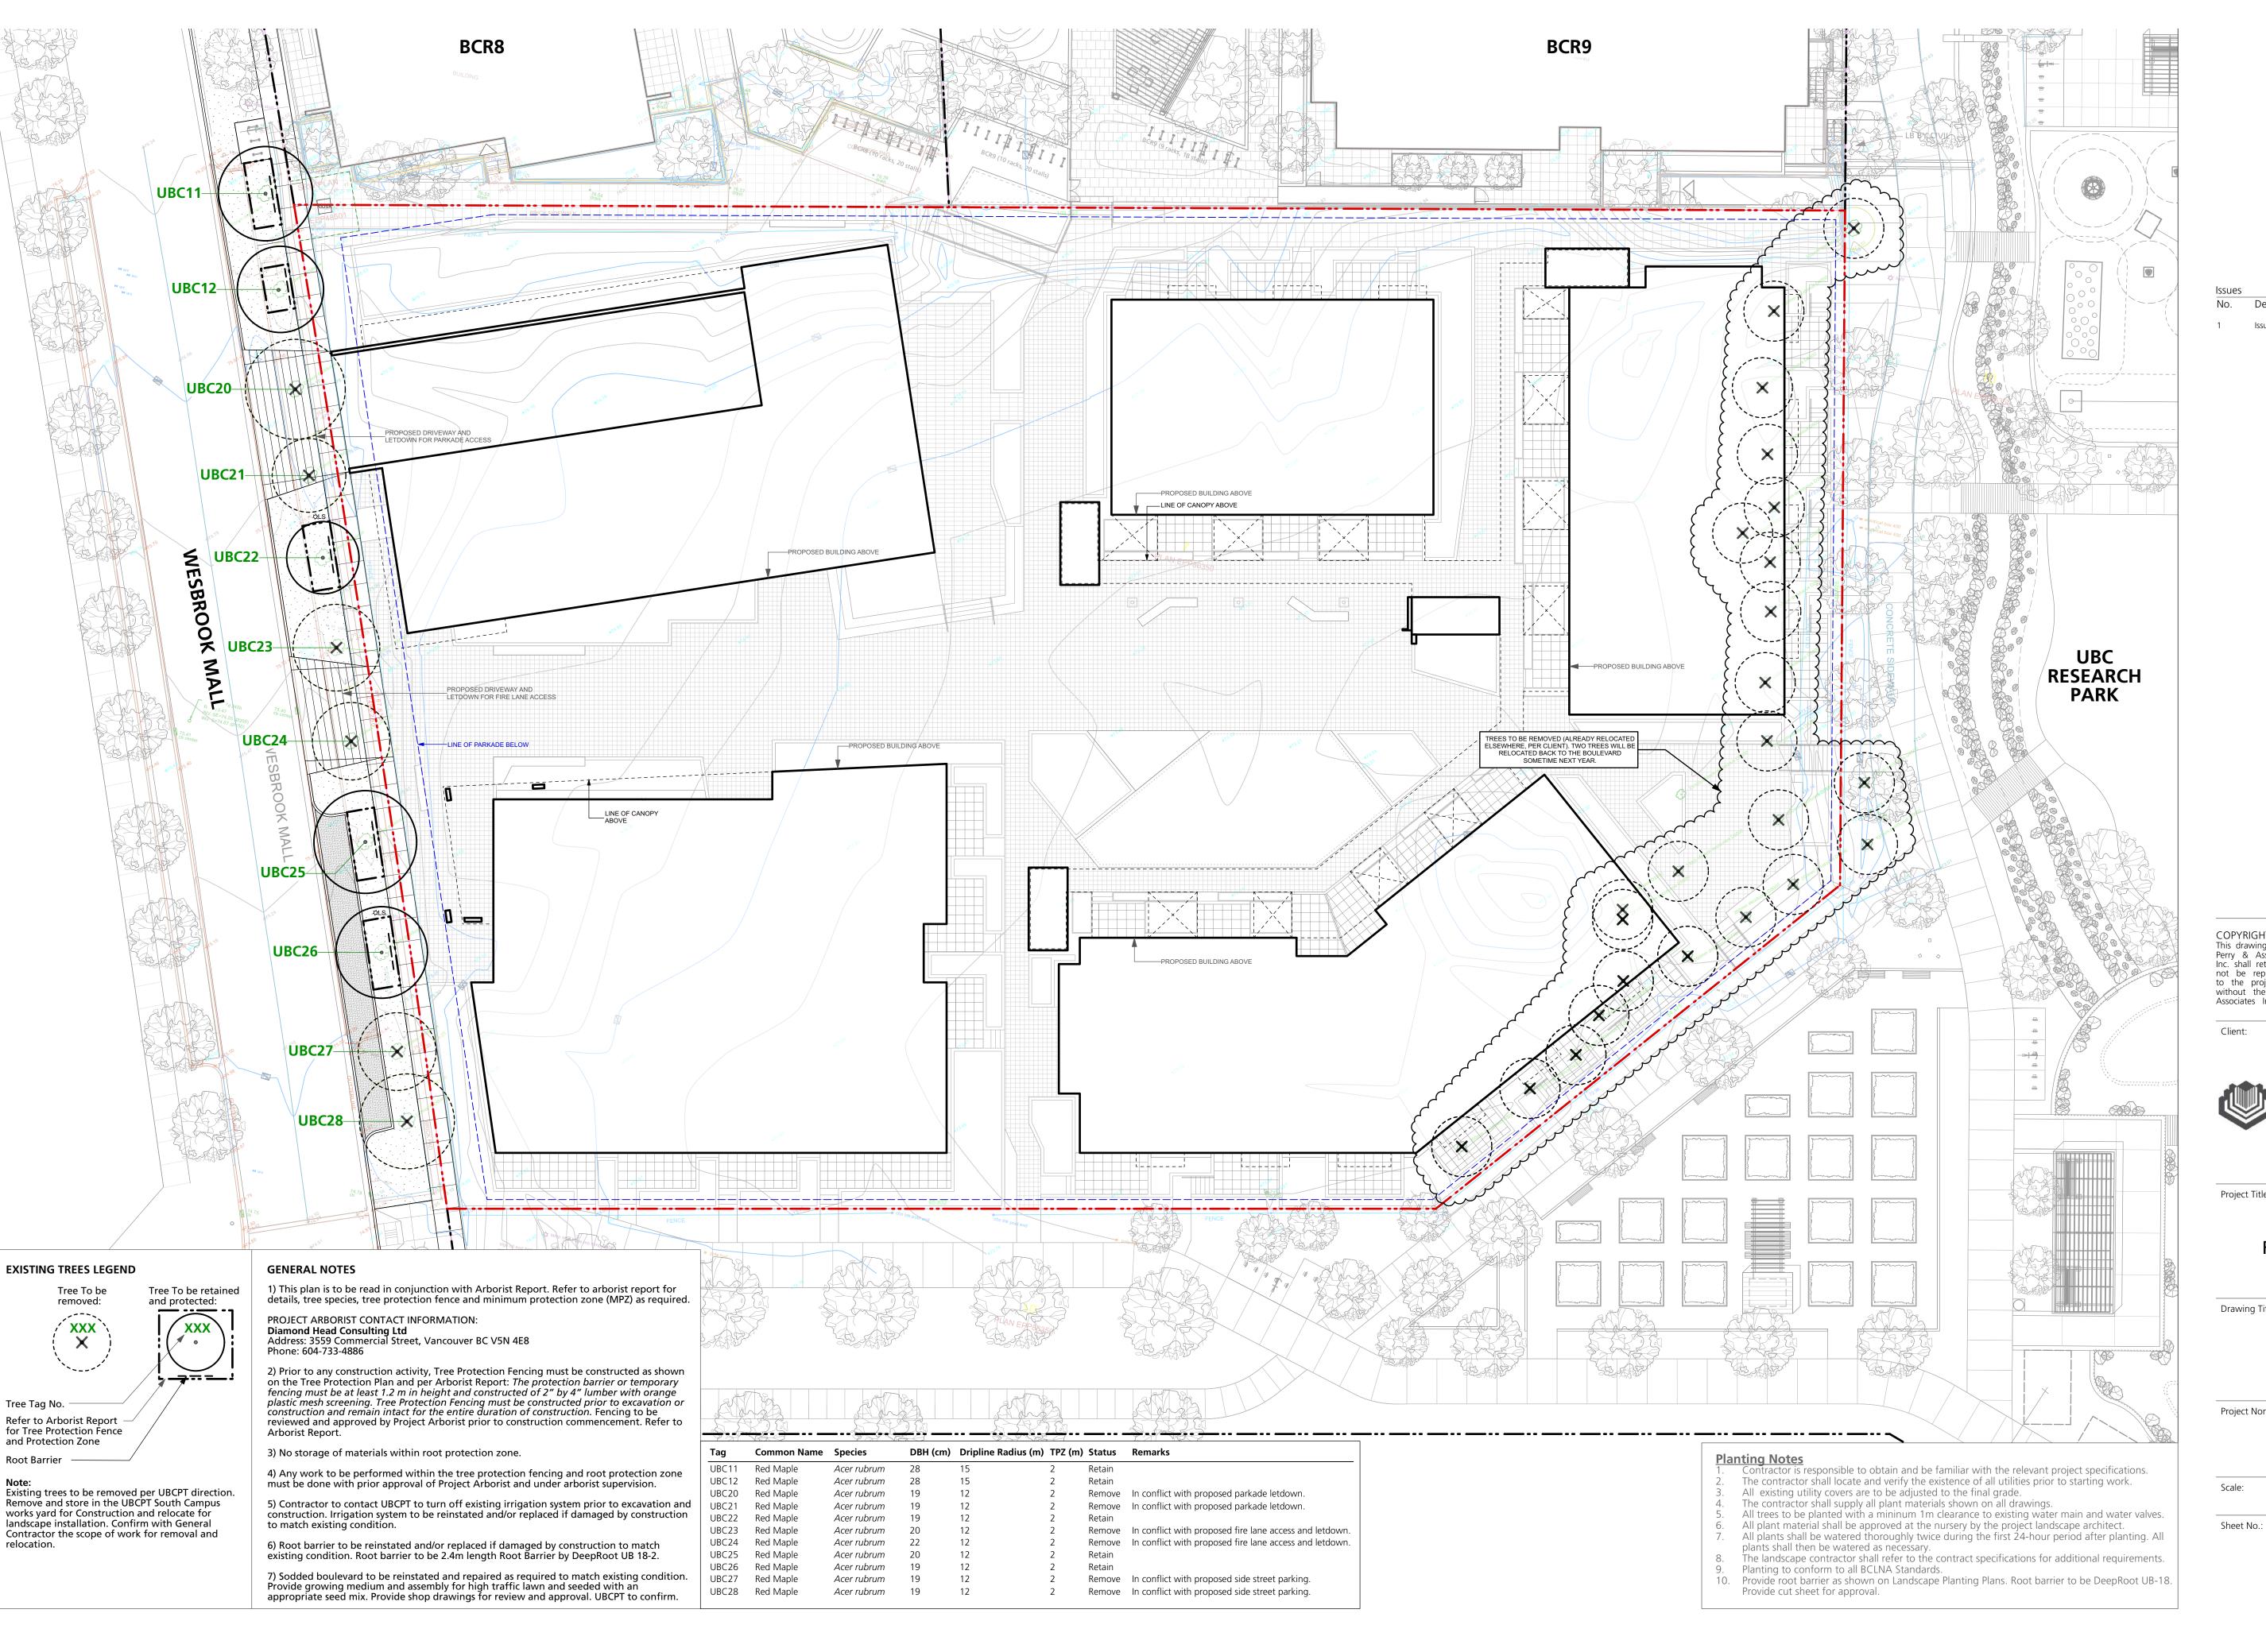

112 East Broadway Vancouver, BC V5T 1V9 T: 604.738.4118 perryandassociates.ca

2024-06-04

Description

Issued for Development Permit

COPYRIGHT RESERVED This drawing is and shall remain the property of R. Kim Perry & Associates Inc., and R. Kim Perry & Associates Inc. shall retain the copyright therein. This document shall not be reproduced or used for additions or alterations to the project or for the purpose of any other project without the prior written consent of R. Kim Perry &

Client:



JBC PROPERTIES TRUST

Project Title:

BC Research Lot 7 **Residential Development**

Drawing Title:

Tree Management Plan

Project North: Drawn By: Job No.: 1:200 23-026



5 FARE

Perry + Associates Landscape Architecture Site Planning

112 East Broadway Vancouver, BC V5T 1V9 T: 604.738.4118 perryandassociates.ca

2024-06-04

Description

COPYRIGHT RESERVED This drawing is and shall remain the property of R. Kim Perry & Associates Inc., and R. Kim Perry & Associates Inc. shall retain the copyright therein. This document shall not be reproduced or used for additions or alterations to the project or for the purpose of any other project without the prior written consent of R. Kim Perry & Associates Inc.

Client:



UBC PROPERTIES TRUST

Project Title:

BC Research Lot 7 Residential Development

Drawing Title:

Landscape Plan

Project North: Job No.: 23-026 1:200

L1.0



112 East Broadway Vancouver, BC V5T 1V9 T: 604.738.4118 perryandassociates.ca

Issued for Development Permit 2024-06-04

UBC PROPERTIES TRUST

BC Research Lot 7 Residential Development

Materials, Layout, and Key Plan

Checked By: Job No.: 23-026

L1.1



112 East Broadway Vancouver, BC V5T 1V9 T: 604.738.4118 perryandassociates.ca


2024-06-04

UBC PROPERTIES TRUST

BC Research Lot 7 Residential Development

Exterior Lighting Plan

23-026

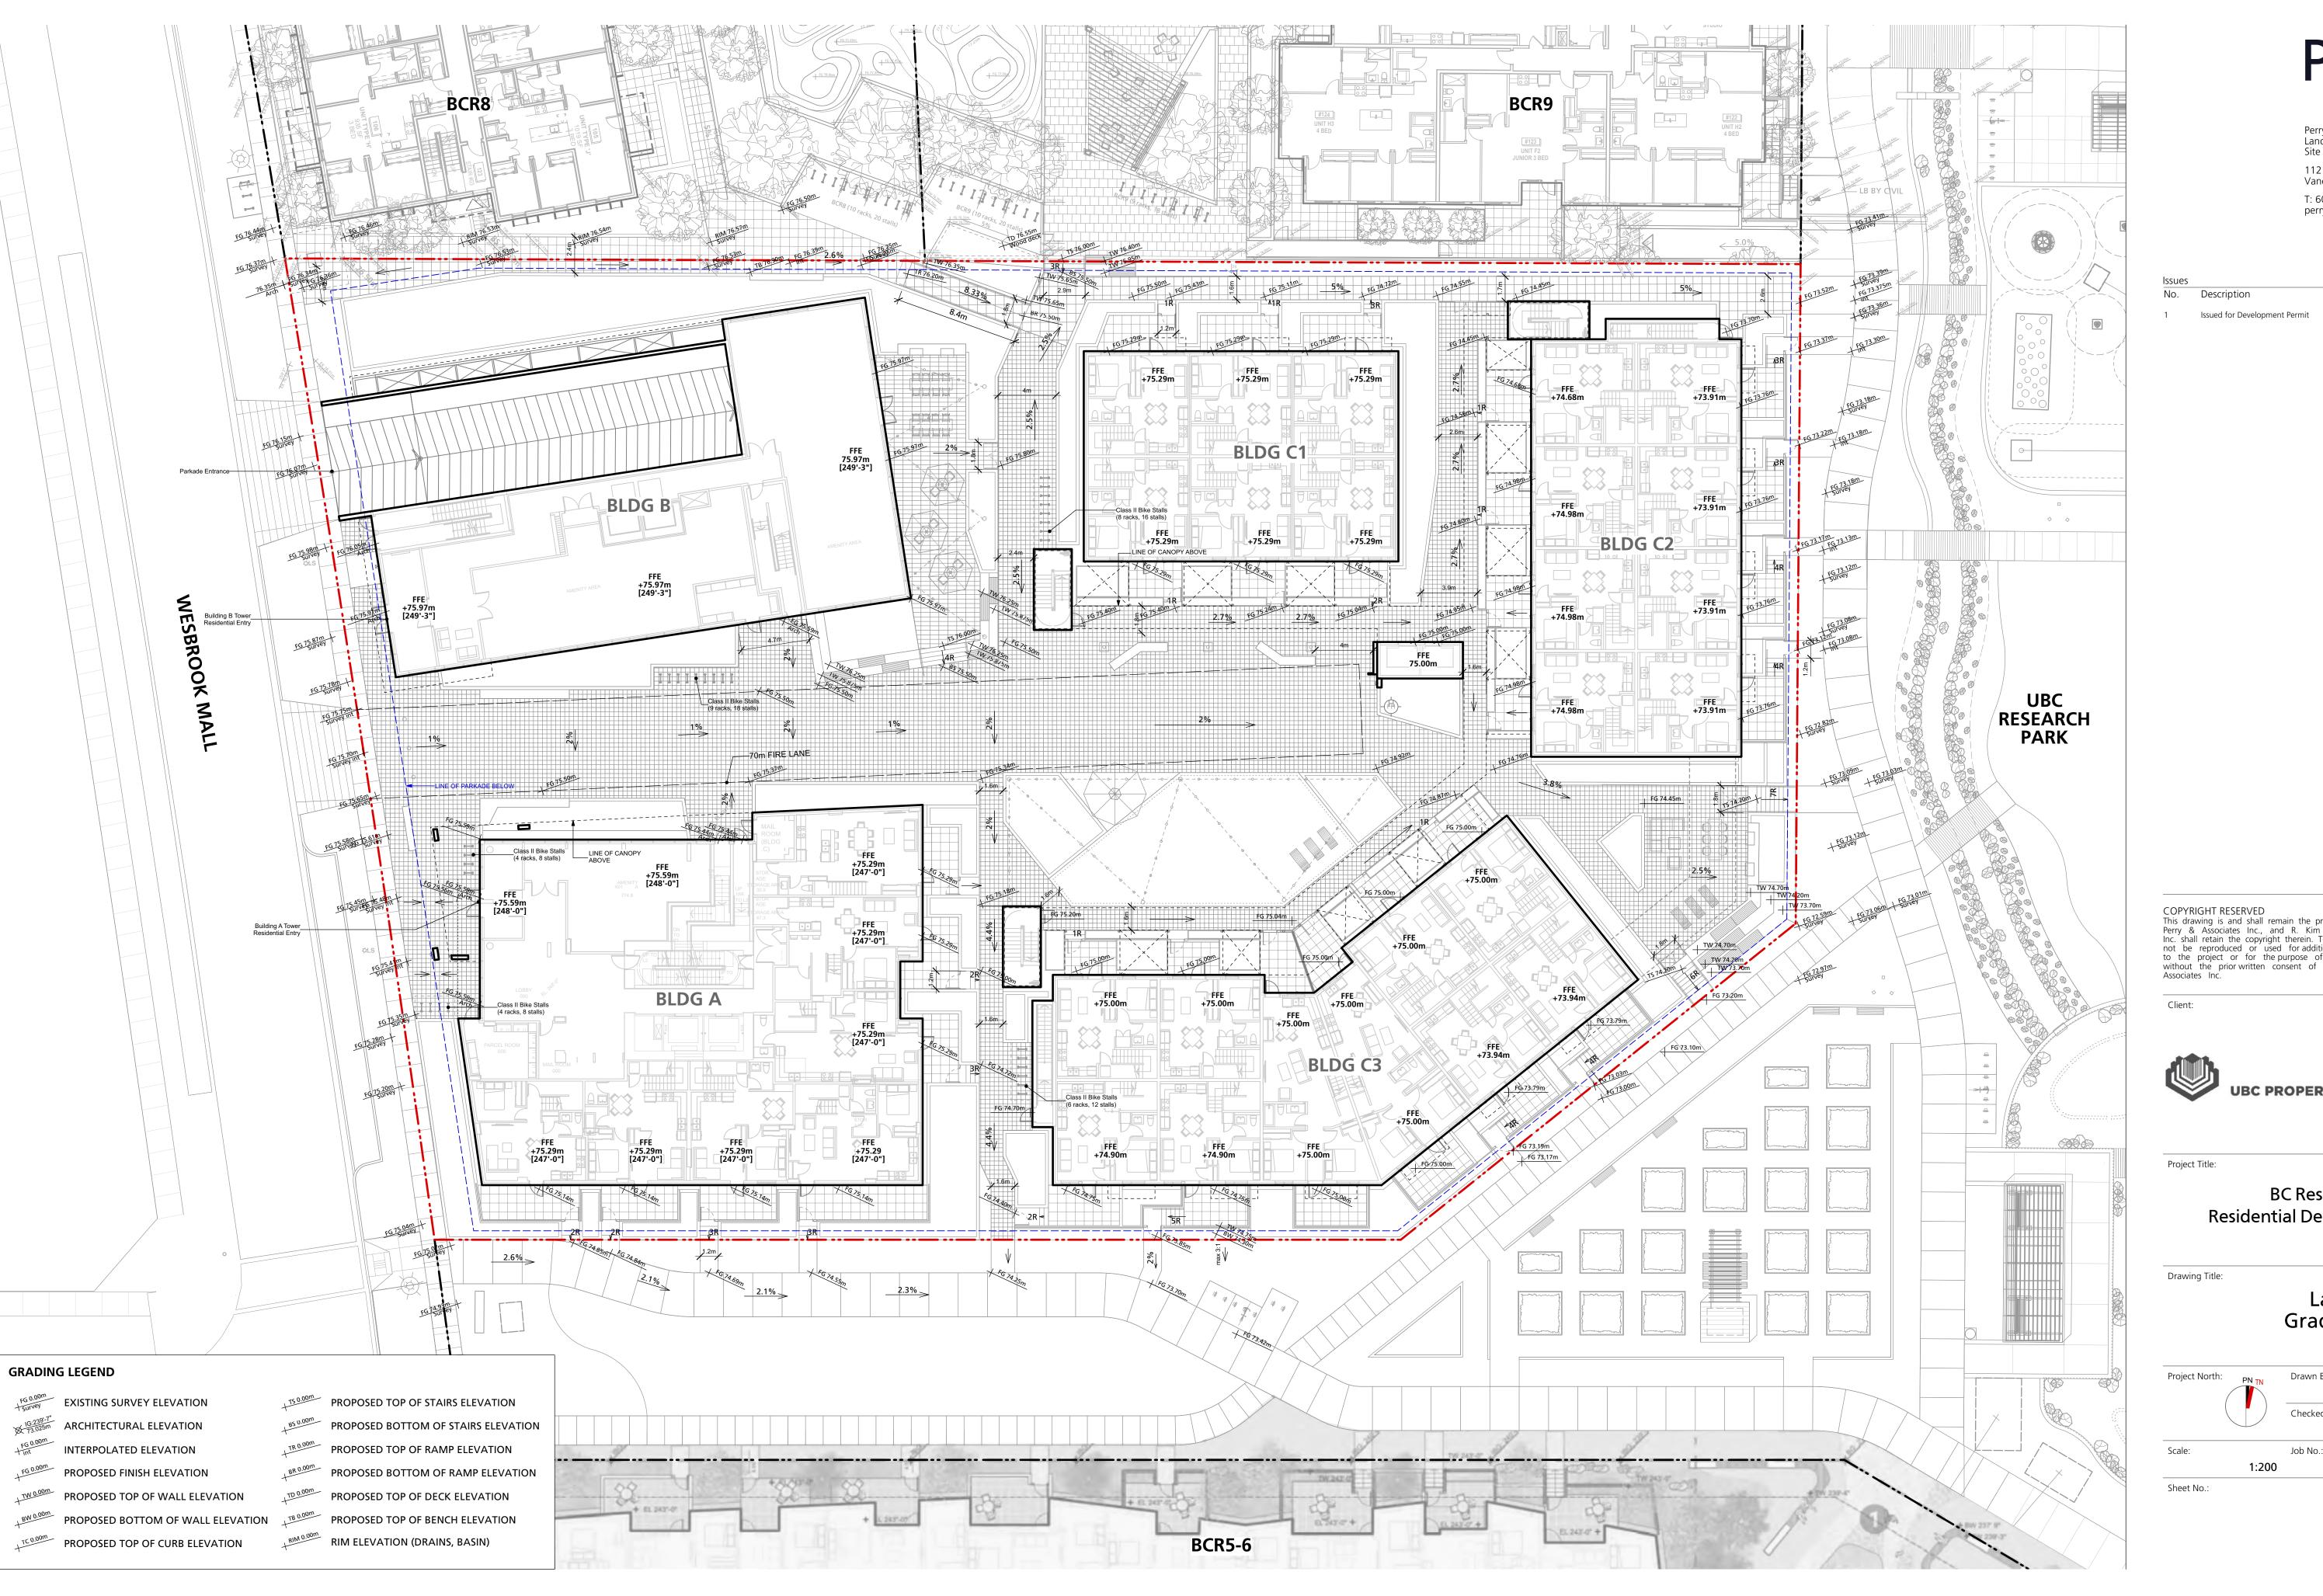

112 East Broadway Vancouver, BC V5T 1V9 T: 604.738.4118 perryandassociates.ca

2024-06-04

This drawing is and shall remain the property of R. Kim Perry & Associates Inc., and R. Kim Perry & Associates Inc. shall retain the copyright therein. This document shall not be reproduced or used for additions or alterations to the project or for the purpose of any other project without the prior written consent of R. Kim Perry & Associates Inc.


UBC PROPERTIES TRUST

BC Research Lot 7 Residential Development

Landscape Grading Plan

Checked By: Job No.: 23-026

L2.0

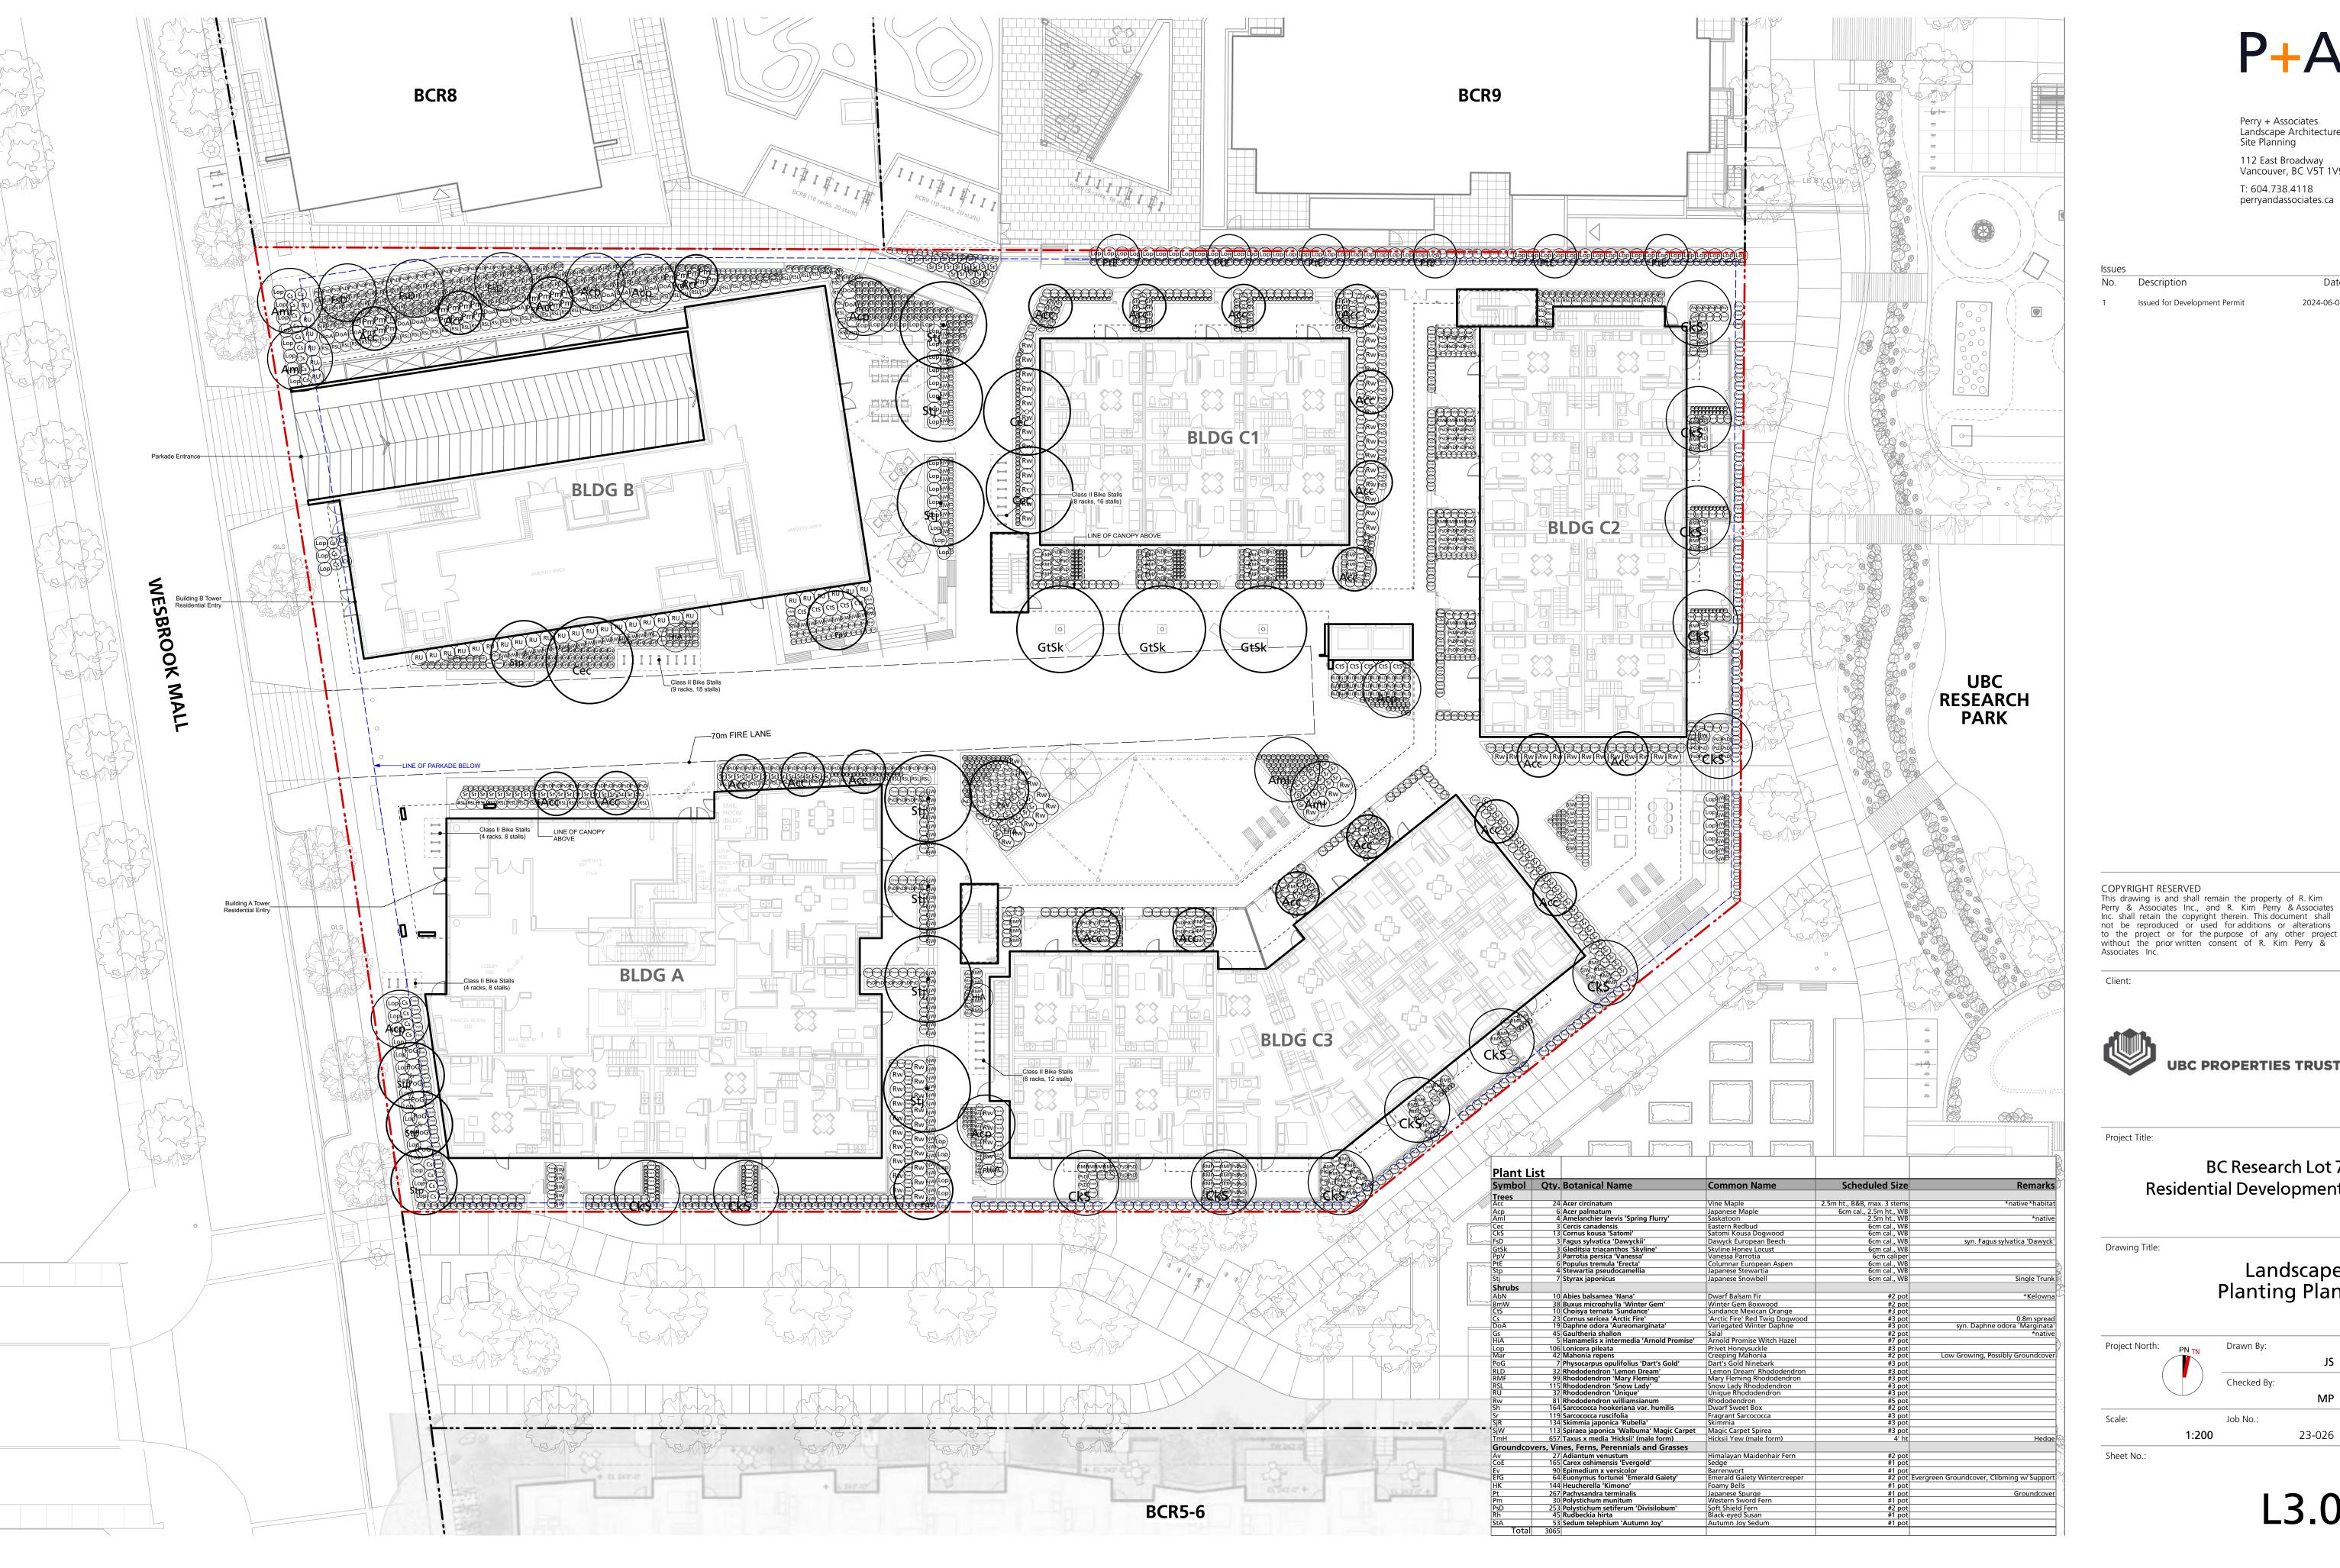

112 East Broadway Vancouver, BC V5T 1V9 T: 604.738.4118 perryandassociates.ca

2024-06-04

This drawing is and shall remain the property of R. Kim Perry & Associates Inc., and R. Kim Perry & Associates Inc. shall retain the copyright therein. This document shall not be reproduced or used for additions or alterations


UBC PROPERTIES TRUST

BC Research Lot 7 Residential Development


Landscape Planting Plan

Checked By: Job No.: 23-026


L3.0

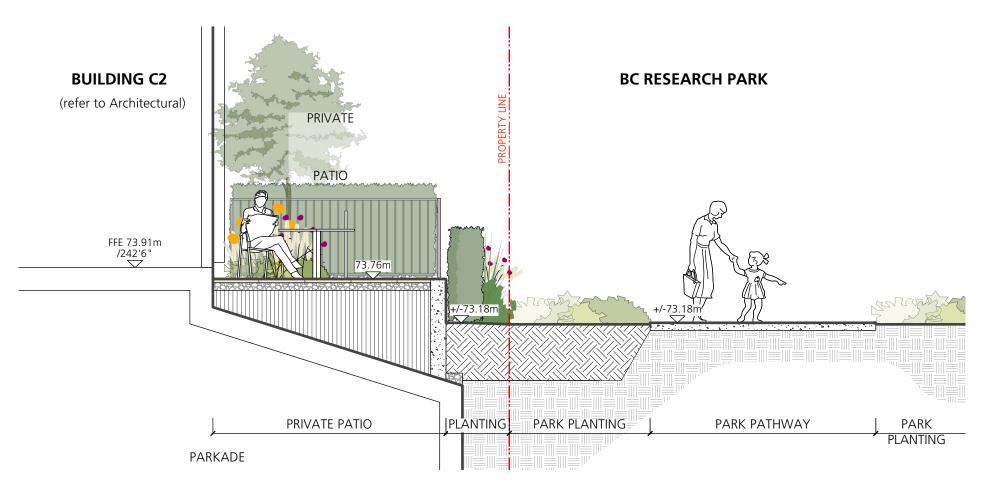


A Section A @ Bldg. C2
L4.0 Scale: 1:50

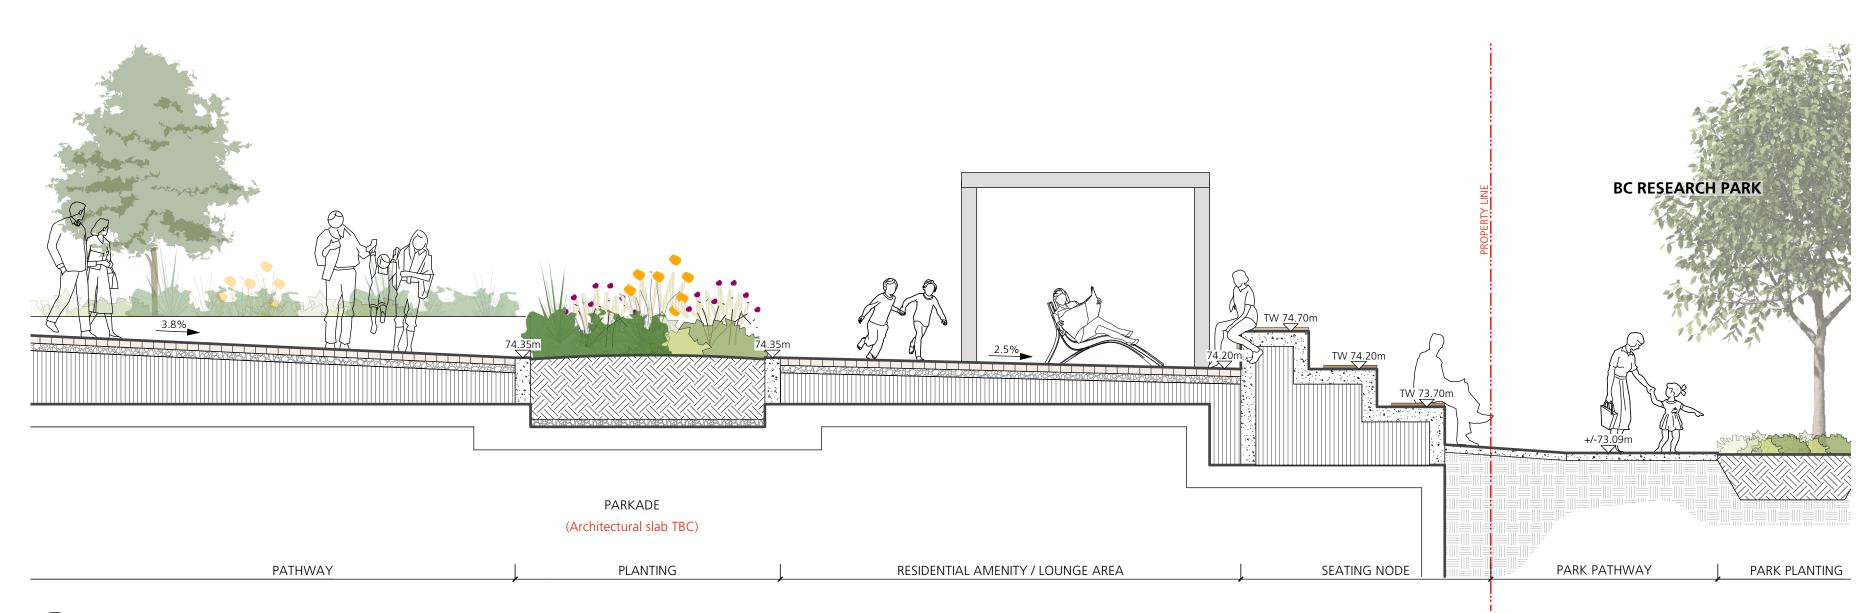

B Section B @ Between Bldg. C2 & C3
L4.0 Scale: 1:50

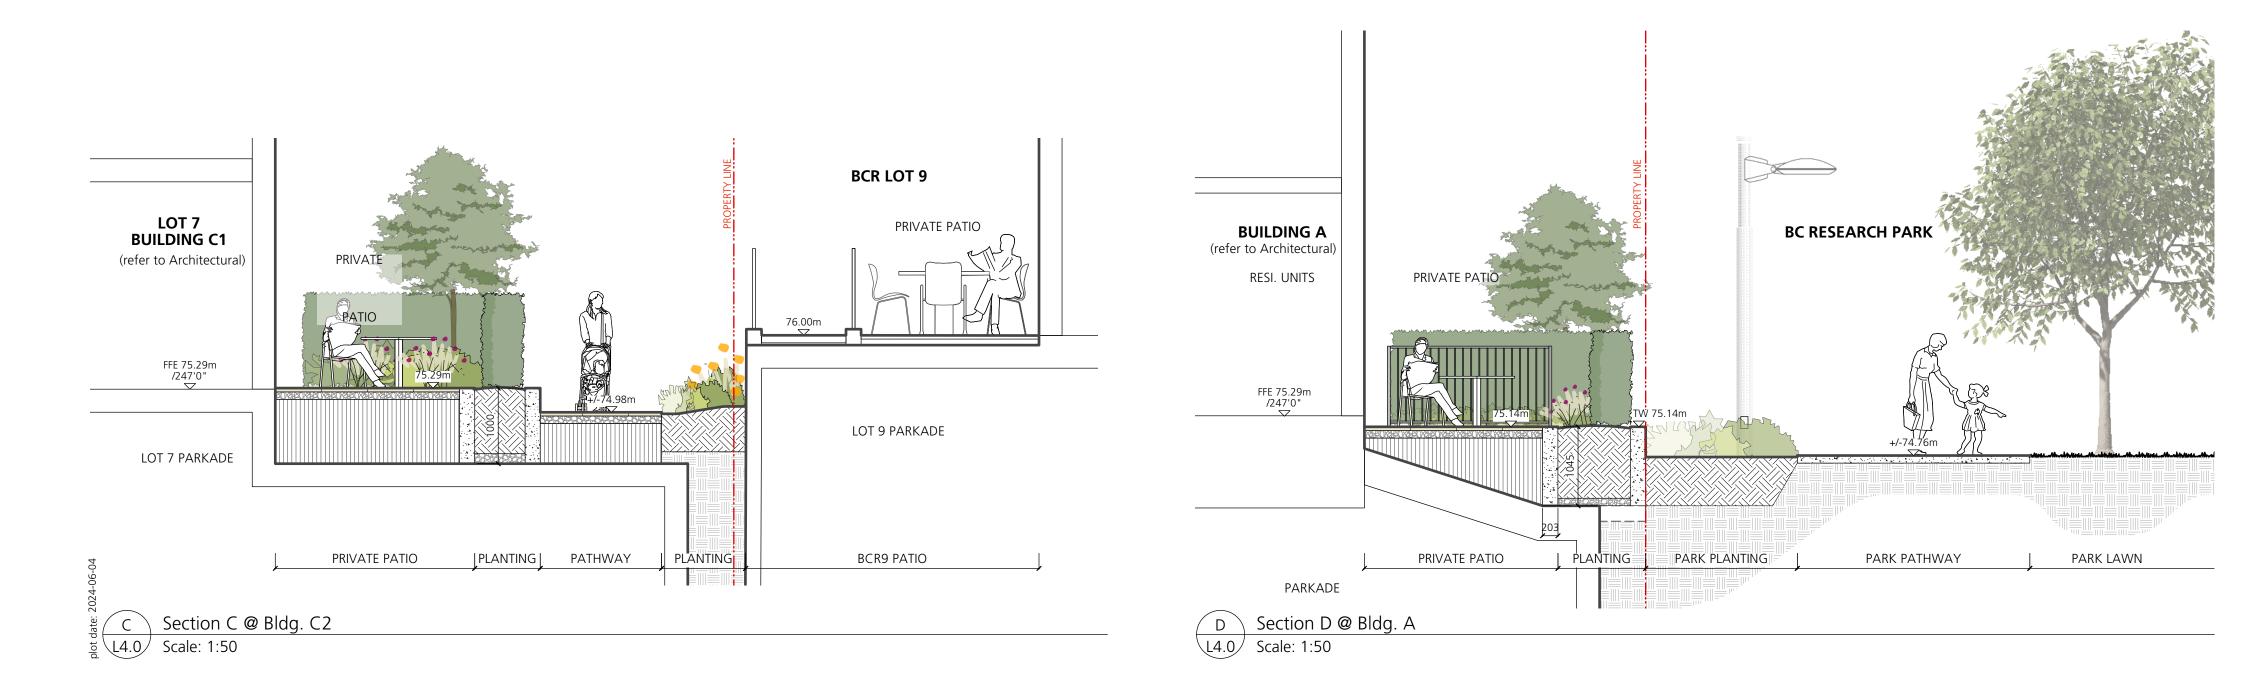

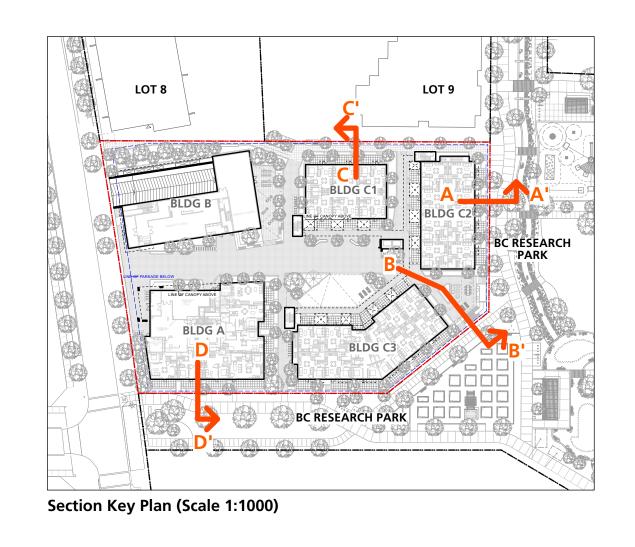

Section Scale Bar

Perry + Associates Landscape Architecture Site Planning 112 East Broadway Vancouver, BC V5T 1V9 T: 604.738.4118 perryandassociates.ca

Description Issued for Development Permit 2024-06-04

COPYRIGHT RESERVED This drawing is and shall remain the property of R. Kim Perry & Associates Inc., and R. Kim Perry & Associates Inc. shall retain the copyright therein. This document shall not be reproduced or used for additions or alterations to the project or for the purpose of any other project without the prior written consent of R. Kim Perry & Associates Inc.

Client:




UBC PROPERTIES TRUST

Project Title:


BC Research Lot 7 Residential Development

Drawing Title:

Landscape Illustrative Sections

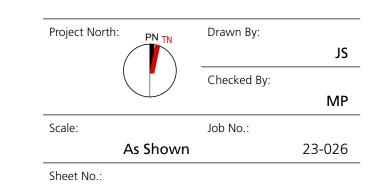


L4.0

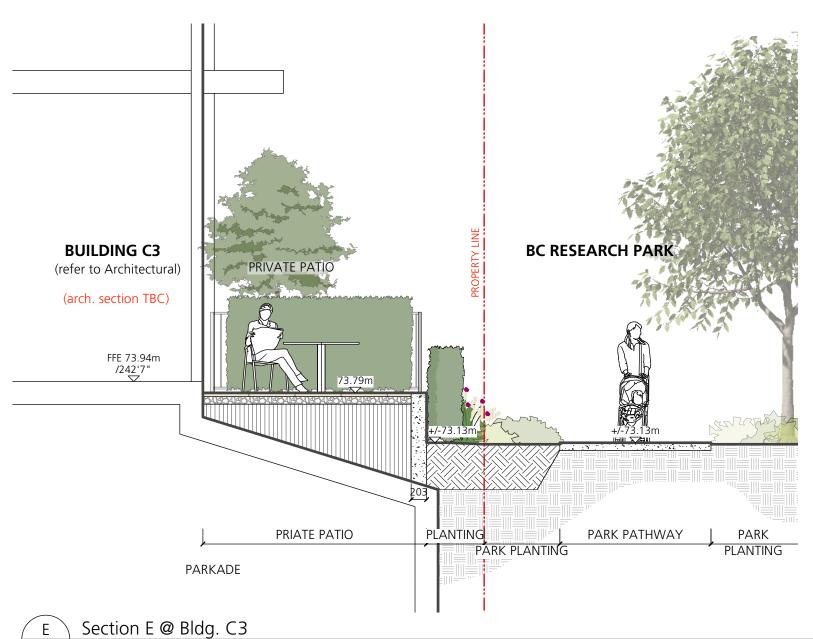

LOT 9 BC RESEARCH BC RESEARCH PARK Section Key Plan (Scale 1:1000)

Section Scale Bar

E Section E @ Bldg. C3
L4.1 Scale: 1:50

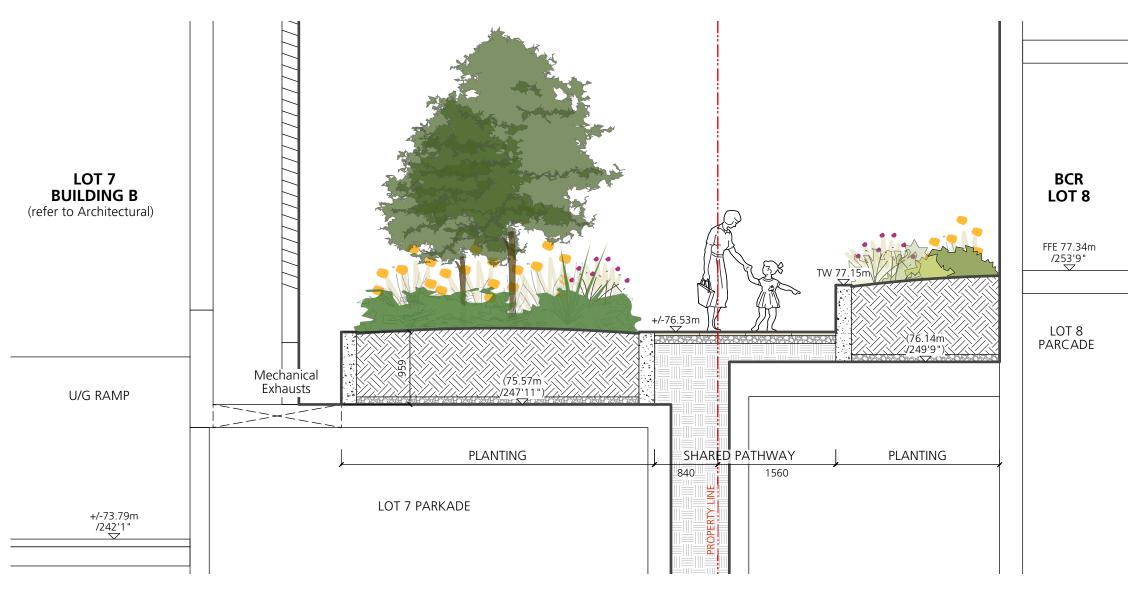

BUILDING A (BUILDING B BEYOND) **BUILDING B** (refer to Architectural) (refer to Architectural) **AMENITY** (TOP OF SEAT BEYOND FFE 75.59m /248'0" (refer to Architectural) FIRE LANE PLANTING BIKE PARKING PLANTING PARKADE

F Section F @ Bldg. B L4.1 Scale: 1:50

G Section G @ Between Bldg. A & B L4.1 Scale: 1:50

Perry + Associates Landscape Architecture Site Planning 112 East Broadway Vancouver, BC V5T 1V9 T: 604.738.4118 perryandassociates.ca

Description Issued for Development Permit 2024-06-04

COPYRIGHT RESERVED This drawing is and shall remain the property of R. Kim Perry & Associates Inc., and R. Kim Perry & Associates Inc. shall retain the copyright therein. This document shall not be reproduced or used for additions or alterations to the project or for the purpose of any other project without the prior written consent of R. Kim Perry & Associates Inc.

Client:




Project Title:


BC Research Lot 7 Residential Development


Drawing Title:


Landscape Illustrative Sections


Project North: Checked By: Scale: Job No.: 23-026 As Shown Sheet No.:

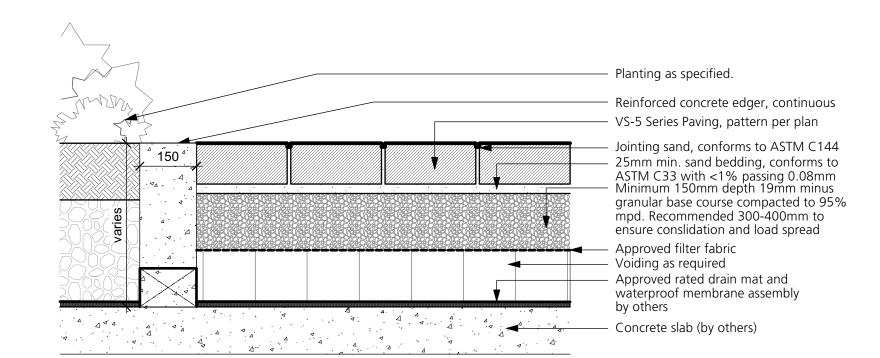

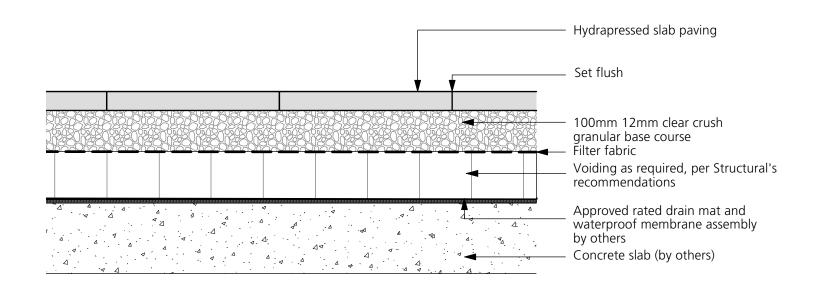


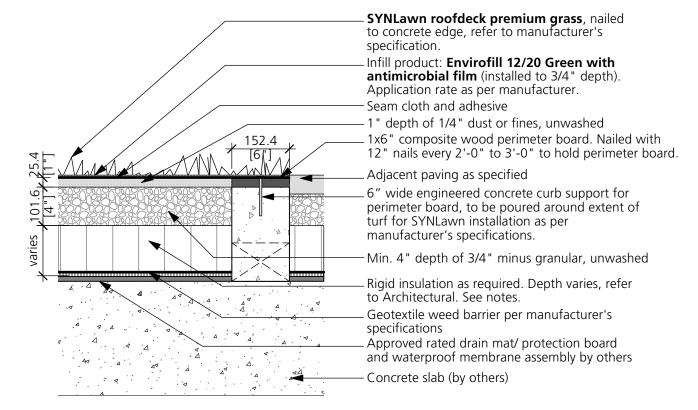

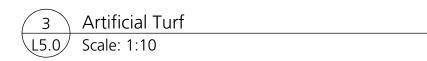


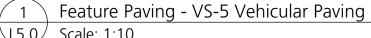



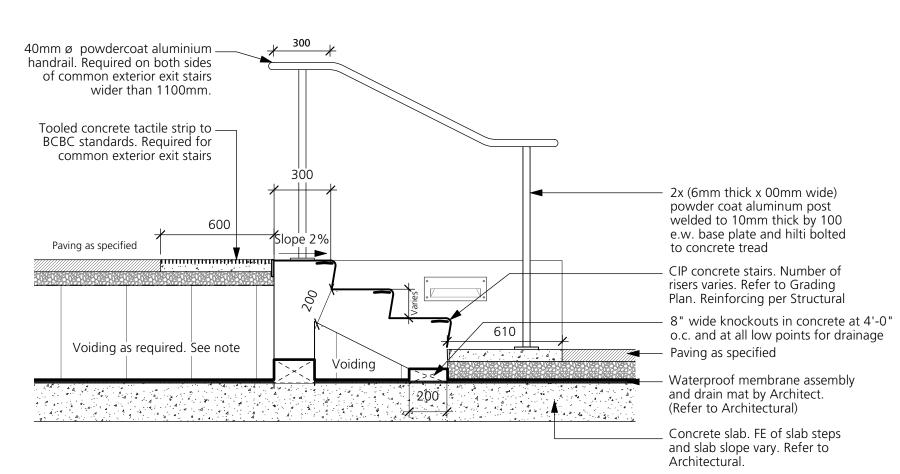




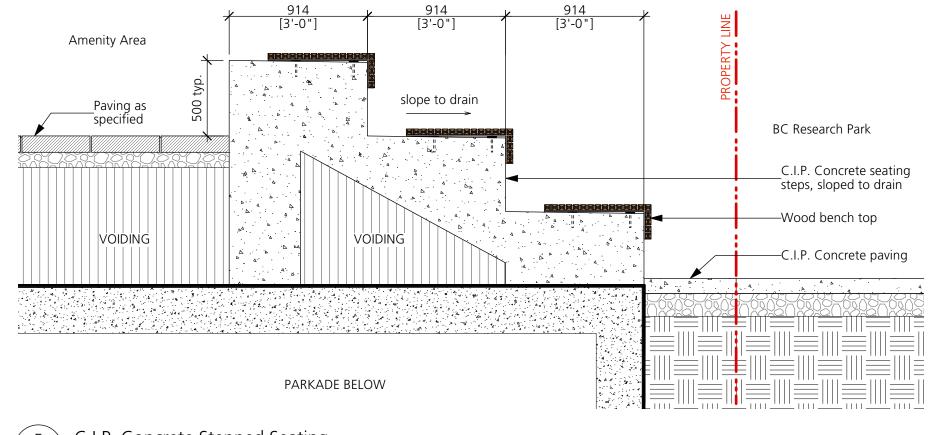

5 C.I.P. Concrete Stepped Seating L5.0 Scale: 1:25

Hydrapressed Slab Paving

L5.0 Scale: 1:10

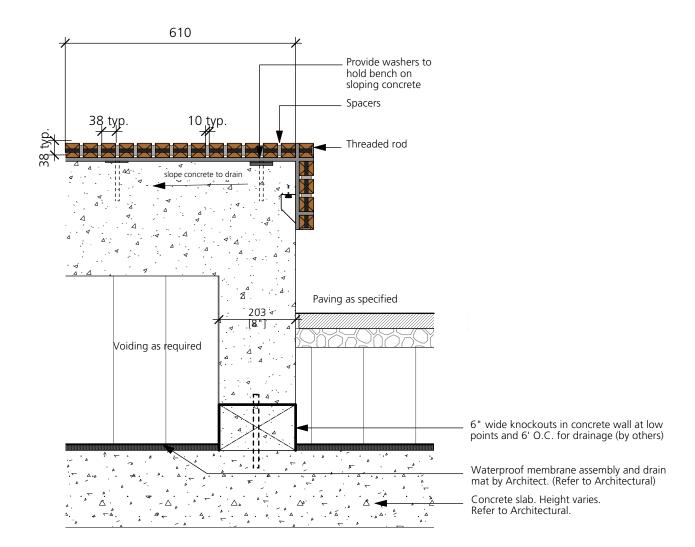

6 Wood Bench L5.0 Scale: 1:10

COPYRIGHT RESERVED
This drawing is and shall remain the property of R. Kim
Perry & Associates Inc., and R. Kim Perry & Associates
Inc. shall retain the copyright therein. This document shall
not be reproduced or used for additions or alterations
to the project or for the purpose of any other project
without the prior written consent of R. Kim Perry &
Associates Inc.

Client:



UBC PROPERTIES TRUST

Perry + Associates

112 East Broadway

T: 604.738.4118

Description

Issued for Development Permit

Site Planning

Landscape Architecture

Vancouver, BC V5Ť 1V9

perryandassociates.ca


2024-06-04

Project Title:

BC Research Lot 7 Residential Development

Drawing Title:


Hardscape Details

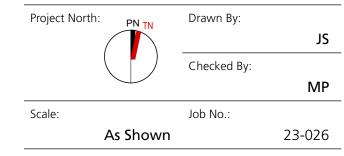

Sheet No.:

L5.0

plot date: 2024-06-04

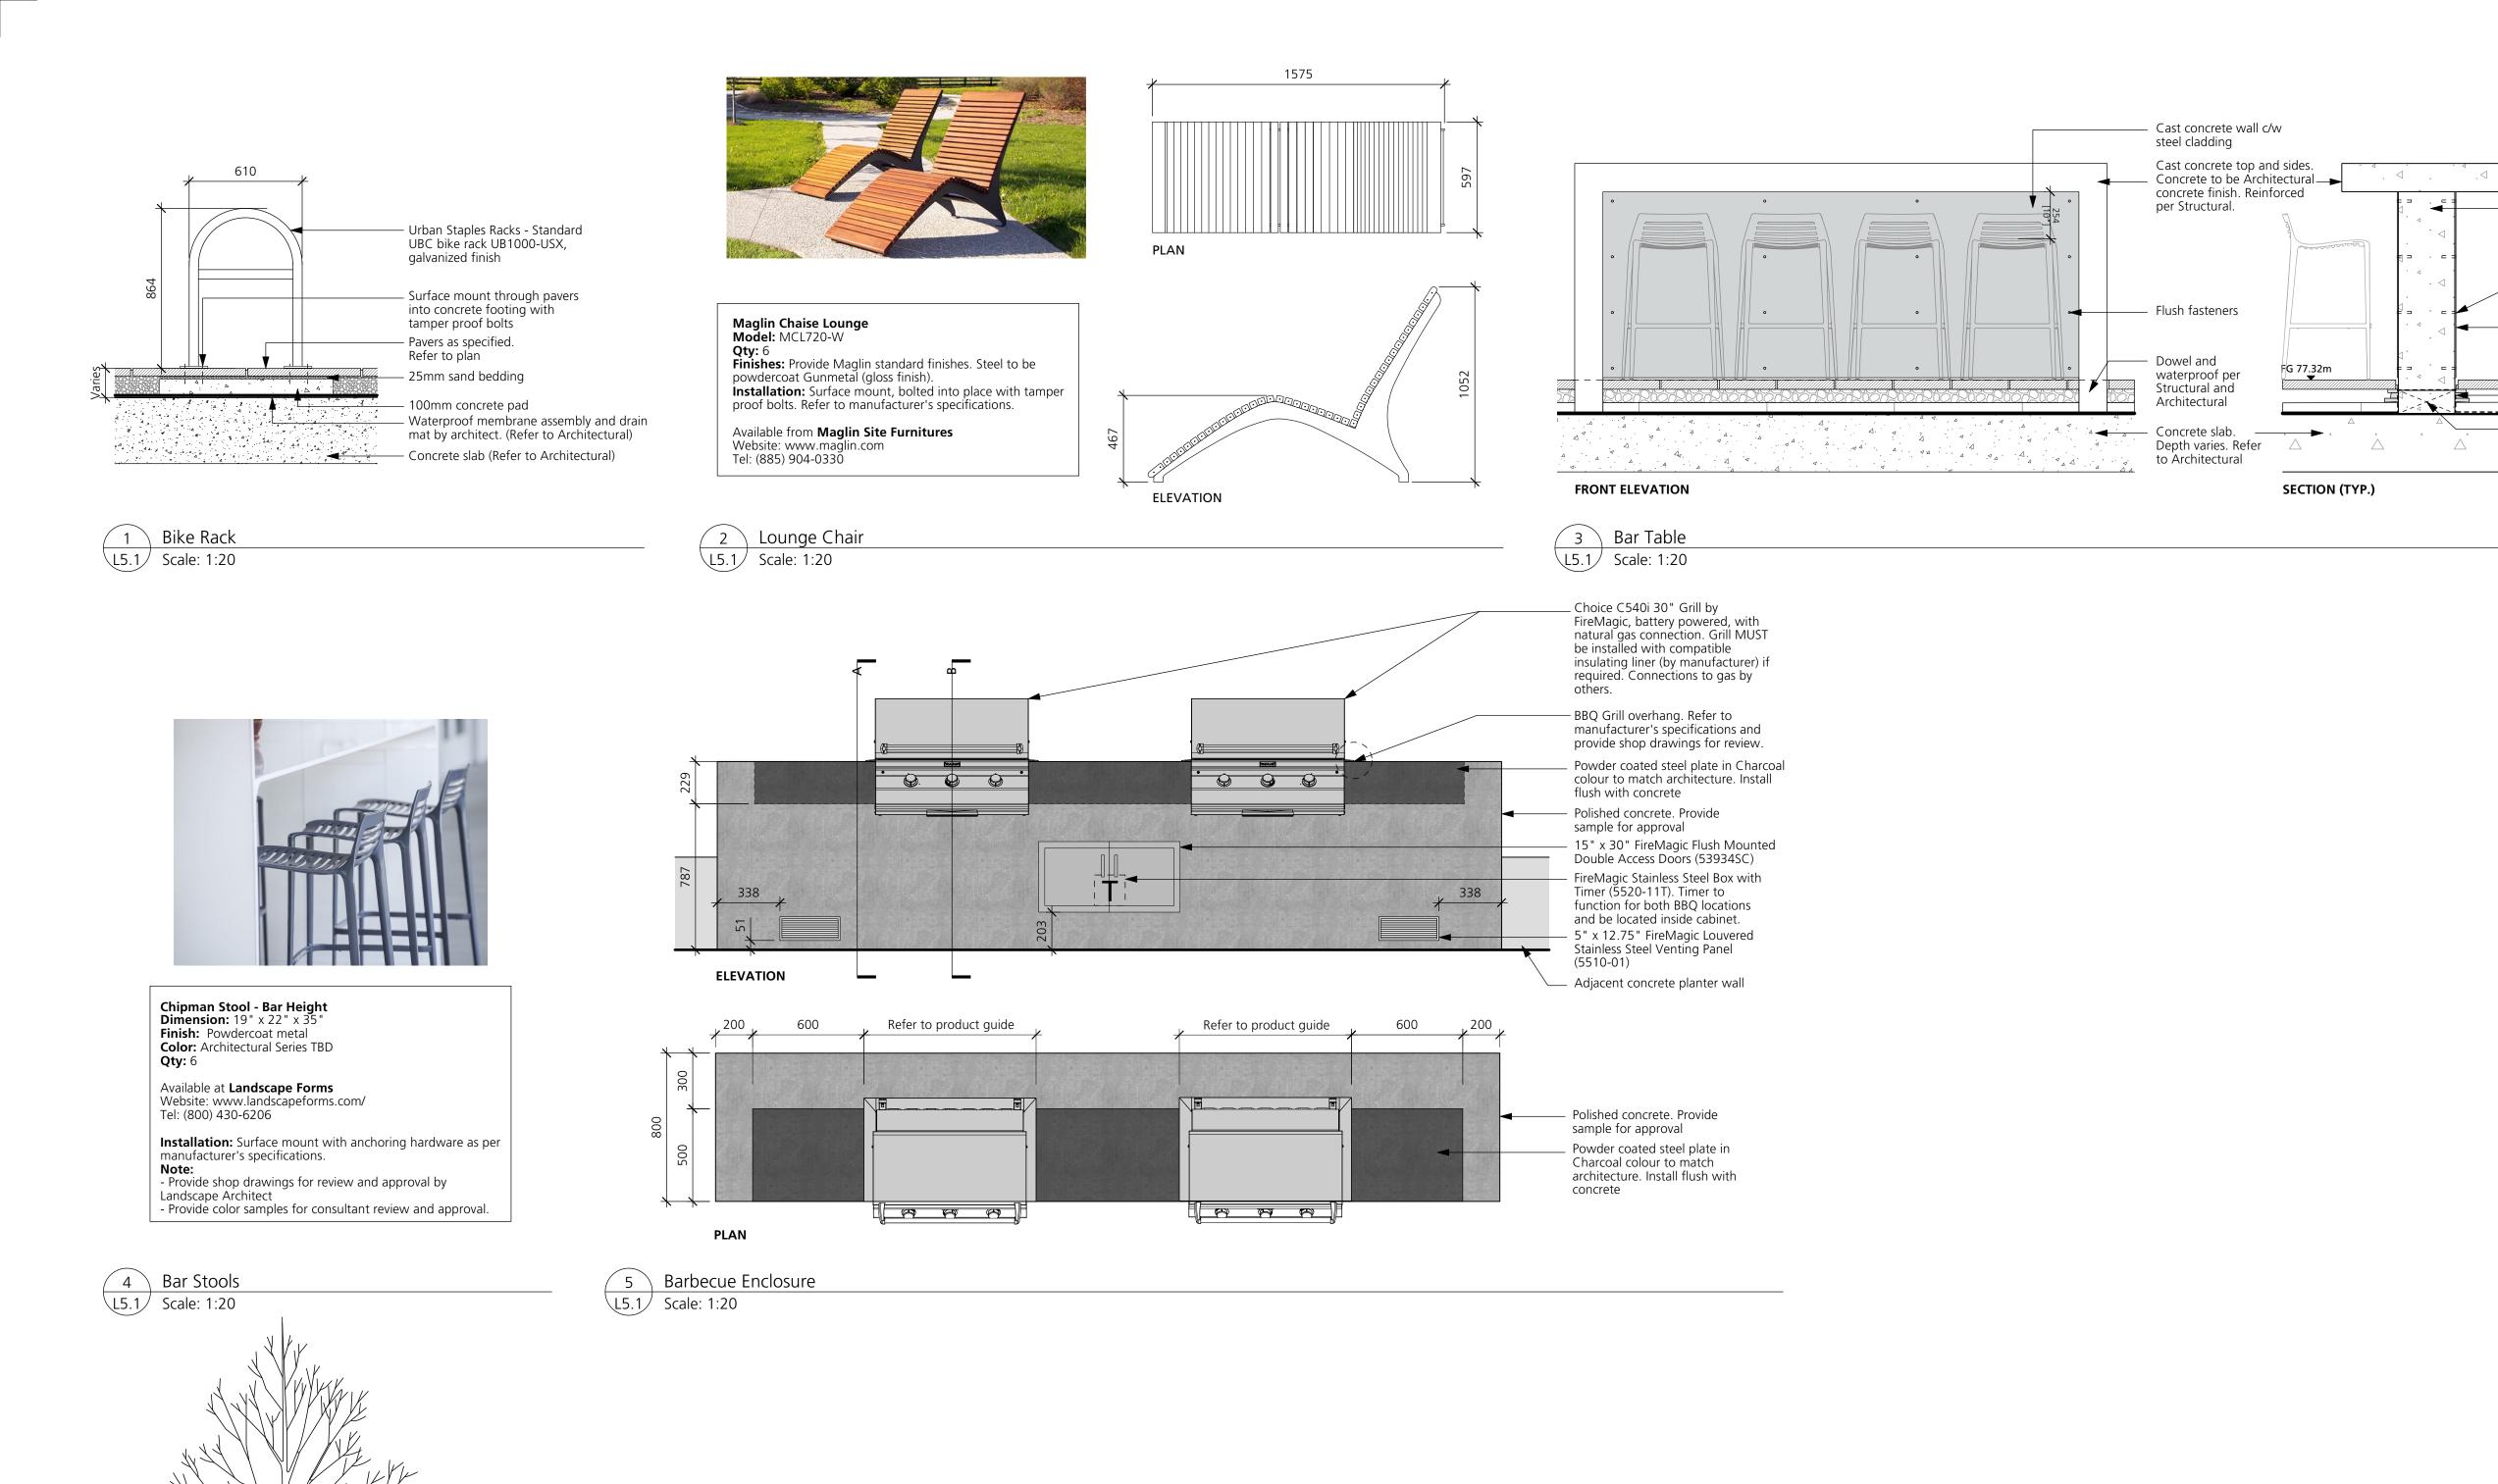

1. Do not cut leader.

protected from sun, frost or dessication.

drainage services must be installed to suit.

thoroughly wetted once per week (minimum).

damage from string trimmers or mowers.

and who demonstrates proficiency in pruning.

2. Protect tree from danger during planting. Ensure rootball is

3. Tree selection, handling, planting and maintenance must meet

BCSLA/BCLNA standards, be in good health and condition without

5. Planting holes must be free draining to the extent that rainwater and/or supplemental water does not accumulate and drown the roots.

If necessary, the subgrade must be graded with positive slope and/or

6. Watering of the root ball must be undertaken immediately after

planting and then for the first growing season so that the root ball is

7. The mulched root zone should be refreshed annually to replace the mulch. This area must be weeded by hand to avoid trunk and root

establishment and from time to time to train it for structure to conform to the form of the species and to respond to growing site constraints.

All pruning must be undertaken by or performed under the direction of

a qualified arborist certified by the International Society of Arboriculture

8. The tree should be pruned to ANSI A3000 standards after

wounds, have normal form, and be free of diseases and pests.

4. Site preparation must include provision for soil placement,

replacement or enhancement to meet project specifications.

Refer to Planting Plan L3.0 for off-site tree locations

ball on all sides with sloped side walls (off-slab conditions).

Install plastic slotted tree trunk protector to guard against

Set root ball flush to grade or 25-50mm higher in poorly

Place root ball at same level as original nursery planting.

to aid in directing supplemental water to the root ball.

Tamp soil around the base of root ball base firmly with

Root ball - cut and fold back ties when planting medium

Approved compacted subgrade or subbase as per Geotech

to Landscape Planting Plan L3.0 for locations.

foot pressure so that root ball does not shift.

100 to 150mm deeper than root ball.

6 Tree Planting

L5.1 Scale: 1:25

75mm built-up earth saucer beyond edge of the root ball

Backfill must be of approved growing medium for quality, composition and fertility. Lightly tamp the backfill and water

450mm [18"] deep root barrier (UB 18-2 from DeepRoot, 2.4m [8']

length) at every tree beside sidewalk and/or greenway. Root barrier

to be flush with top of sidewalk and against sidewalk edges. Refer

draining soils. Do not cover the top of the root ball with soil.

Planting hole must be dug to at least 300mm larger than the root

to give best appearance in relation to structure, roads and walks.

damage from string trimmers where trees are planted in lawn.

Tree must be vertical and stable after planting. Orient plant material

Perry + Associates Landscape Architecture Site Planning 112 East Broadway Vancouver, BC V5T 1V9

T: 604.738.4118

perryandassociates.ca

2024-06-04

Description

Issued for Development Permit

Concrete upstand. Reinforced per Structural.

Provide flush fasteners

painted to match steel

1/4" thick steel cladding

to match Architectural

Precurb assembly to

Provide 8" wide knockouts

in precurb at low points

and 6' O.C. for drainage

match Architectural

as shown

(by others)

charcoal color

COPYRIGHT RESERVED This drawing is and shall remain the property of R. Kim Perry & Associates Inc., and R. Kim Perry & Associates Inc. shall retain the copyright therein. This document shall not be reproduced or used for additions or alterations to the project or for the purpose of any other project without the prior written consent of R. Kim Perry & Associates Inc.

Client:



Project Title:

BC Research Lot 7 Residential Development

Drawing Title:

Project North: Checked By: Job No.: As Shown 23-026

Shrub Planting L5.1 Scale: 1:20

Thin branches by 1/3 retaining

Planting hole and root ball must be

mulch. Do not put mulch against the

covered with 50mm of composted

- Shrubs shall be slightly higher in

to previous existing grade.

300 to 450mm (for larger

water in after planting.

shrub root balls, make depth

min. 100mm deeper than ball)

Backfill must be of approved growing

medium for quality, composition and

fertility. lightly tamp the backfill and

relation to finished than they were

1. Min. root spread to be in accordance with "american standards for

2. For container-grown shrubs, use fingers or small hand tools to pull the

roots out of the outer layer of potting soil; then cut or pull apart any roots

that circle the perimeter of the container. prune all damaged, diseased, or

4. Fold burlap from top of root ball down into ground set top of ball flush

5. Do not allow roots to dry out during installation process.

6. Soak roots in water overnight before planting.

nursery stock."

weak limbs and roots.

with finish grade.

3. Cleanly prune all damaged root ends.

normal plant shape.

base of the plant.

Furnishing and Planting Details

Sheet No.:

Perry + Associates Landscape Architecture Site Planning 112 East Broadway Vancouver, BC V5T 1V9

T: 604.738.4118 perryandassociates.ca

Issues			
No.	Description	Date	
1	Issued for Development Permit	2024-06-04	



COPYRIGHT RESERVED This drawing is and shall remain the property of R. Kim Perry & Associates Inc., and R. Kim Perry & Associates Inc. shall retain the copyright therein. This document shall not be reproduced or used for additions or alterations to the project or for the purpose of any other project without the prior written consent of R. Kim Perry & Associates Inc.



Project Title:

BC Research Lot 7 Residential Development

Drawing Title:

Precedent Images

Project North: PN TN	Drawn By:	
		JS
	Checked By:	
		MP
Scale:	Job No.:	
NTS		23-026

PLANTING PALETTE


















ARTIFICIAL TURF

BIKE RACK

PATIO PAVING

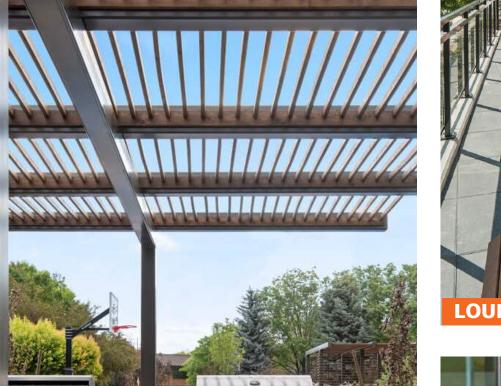










EVERGREEN HUCKLEBERRY






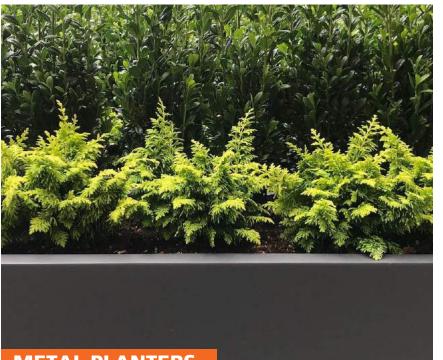





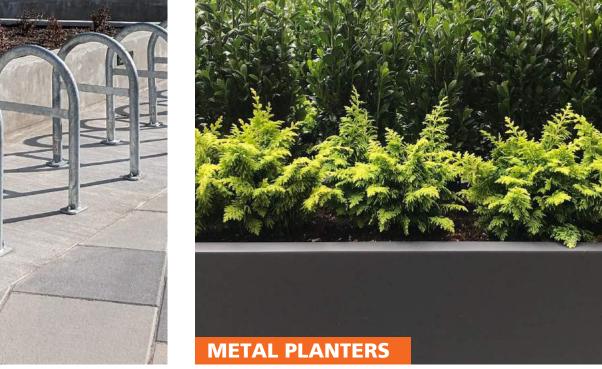



OUTDOOR BARBECUE + CANOPY









PATIO STAIRS

WALL BENCHES

LIT BOLLARDS

L6.0