



UBC Applied Science Digital Design Studio

2360 East Mall, Vancouver, BC V6T 1Z3

Issued for Development Permit

March 31 2023

ARCHITECT SHAPE Architecture

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Architect

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Fast+Epp 397 W 7th Ave #300,

STRUCTURAL

Vancouver, BC V5Y 1M2 Duane Palibroda, Principal dpalibroda@fastepp.com Jamie Pobre Sullivan, Senior jpobresullivan@fastepp.com

MECHANICAL AME

638 Smithe St Suite 200, Vancouver, BC V6B 1E3 Patrick Stewart, Principal patrickstewart@amegroup.ca James Wong, Associate jameswong@amegroup.ca

ELECTRICAL PBX 131 Water St #300,

Vancouver, BC V6B 4M3 David Carter, Lead david.carter@pbxeng.com Darcy Metz, Design Engineer darcy.metz@pbxeng.com

CIVIL CoreGroup 8988 Fraserton Ct,

Burnaby, BC V5J 5H8 Cormac Nolan, Principal cnolan@coregroupconsultants.com Scott Robbins, Engineer

srobbins@coregroupconsultants.com

BUILDING ENVELOPE Entuitive 1075 W Georgia St Suite 1020, Vancouver, BC V6E 3C9

Mike Lembke, Principal mike.lembke@entuitive.com Timothy Wong, Building Envelope timothy.wong@entuitive.com

EXP Services Inc. 3001 Wayburne Drive Suite 275 Burnaby, BC V5G 4W3 Ben Weiss, Engineer ben.weiss@exp.com

Derek Chan, Engineer

Derek.Chan@exp.com

GEOTECHNICAL

780 Beatty St, Vancouver, BC V6B 2M1 Alan Jung, Principal ajung@lmdg.com Allan Chen, Project Coordinator

LMDG

BUILDING CODE

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Entuitive Building Specialist jack.statham@entuitive.com

LEED

1075 W Georgia St Suite 1020, Vancouver, BC V6E 3C9 Jack Statham, Senior Sustainable

Entuitive 1075 W Georgia St Suite 1020, Vancouver, BC V6E 3C9 Emily King, Associate

LCA

emily.king@entuitive.com Leanne Conrad, Senior Sustainable leanne.conrad@entuitive.com

GENERAL NOTES 1. ALL LABOUR, MATERIALS AND PRODUCTS TO COMPLY WITH REQUIREMENTS OF THE BRITISH COLUMBIA BUILDING CODE 2018 (BCBC 2018) AND ALL OTHER APPLICABLE CODES, 2. ALL **FLOOR LEVEL ELEVATIONS** ARE TAKEN FROM: TOP OF SHEATHING, TOP OF CONCRETE TOPPING, OR TOP OF CONCRETE STRUCTURE 3. ALL **DIMENSIONS** ARE MEASURED TO A. GRIDLINES FACE OF EXTERIOR SHEATHING FACE OF CONCRETE WALLS CENTRE OF PARTY WALLS FACE OF INTERIOR WOOD STUD CENTRE OF WINDOWS ARCHITECTURAL DRAWINGS TO BE READ IN CONJUNCTION WITH ALL OTHER CONSULTANTS' DOCUMENTS. IF INFORMATION APPEARS IN ONE DRAWING, CONTRACTUALLY IT SHALL BE TAKEN TO APPEAR IN ALL. TYP. FOR SITE SURVEY INFORMATION REFER TO TOPOGRAPHIC SURVEY PLAN OF A PORTION OF DISTRICT LOT 4805, GROUP 1, NEW WESTMINSTER DISTRICT PREPARED BY APLIN & MARTIN GEOMATRICS LAND SURVEYING LTD ALL SERVICE PENETRATIONS THROUGH FIRE RATED ASSEMBLIES TO BE SEALED WITH A FIRESTOP SYSTEM WITH AN 'F' RATING EQUAL TO THAT OF THE ASSEMBLY EXCEPT FOR SPRINKLER PIPING AND NON-COMBUSTIBLE SERVICES SERVING THESE AREAS, ALL SERVICES IN EXIT CORRIDORS AND EXIT STAIRS SHALL BE ENCLOSED IN ULC LISTED FIRE RATED ENCLOSURES WITH A RATING EQUAL TO THE ASSEMBLY PENETRATED. FOLLOW MANUFACTURERS INSTRUCTIONS FOR HORIZONTAL INSTALLATIONS. READ, CHECK AND COMPARE ALL DRAWINGS, NOTIFY THE ARCHITECT OF ANY/ALL DISCREPANCIES. VERIFY ALL DIMENSIONS AND ELEVATIONS BEFORE FABRICATION/CONSTRUCTION OF ANY COMPONENT. 10. SEE WALL SCHEDULE, WALL SECTIONS AND DETAILS FOR ASSEMBLY TYPES AND INTERFACE CONDITIONS.

PROVIDE **SOLID BLOCKING IN WALLS** FOR ALL WALL MOUNTED FIXTURES, MILLWORK AND DOOR STOPS. 12. ALL PUBLIC AREA RAMPS AND STAIRS INCLUDING TREADS, RISERS, AND NOSING TO CONFORM TO VBBL SECTIONS - 3.4.6.1 - 3.4.6.4, 3.4.6.7 - 3.4.6.10 13. ALL PUBLIC AREA HANDRAILS & GUARDS TO CONFORM TO VBBL SECTION - 3.4.6.5 & 3.4.6.6.

14. ALL **FLASHINGS** TO BE MEMBRANE LAPPED & COUNTER FLASHED WITH CLIPS.

15. ALL LOW SLOPE **ROOFS** TO BE MIN. 2% SLOPED TO DRAIN.

16. CONTRACTOR TO ALLOW FOR **FALL RESTRAINT SYSTEM** AS PER WCB.

17. FOR EXIT SIGNS, EMERGENCY LIGHTING, AND FIRE ALARM DEVICES, AS WELL AS LIGHTING PLANS AND FIXTURES, REFER TO ARCHITECTURAL RCPS, ELECTRICAL AND INTERIOR

18. FOR MECHANICAL DUCTING AND ACCESSORIES AND THEIR LOCATIONS, REFER TO MECHANICAL DRAWINGS.

19. **ELECTRICAL AND MECHANICAL FIXTURES** AND DEVICES INDICATED IN THIS DRAWING ARE FOR LOCATION ONLY. REFER TO CONSULTANT DOCUMENTS FOR SPECIFICATIONS. 20. CONTRACTOR TO COORDINATE ALL ELECTRICAL AND MECHANICAL SLAB PENETRATIONS WITH STRUCTURAL REQUIRMENTS PRIOR TO POURING CONCRETE. ANY DISCREPANCIES OR CONFLICTS TO BE REPORTED TO THE ARCHITECT IMMEDIATELY.

21. ALL SPRINKLER LOCATIONS AS PER FIRE SUPPRESSION CONSULTANT

22. FOR INTERIOR FINISHES. REFER TO INTERIOR DESIGN DRAWINGS AND SPECIFICATIONS.

23. ALL ACCESS PANELS IN CEILINGS TO BE LOCATED AS PER PLANS. IF ADDITIONAL ACCESS PANELS ARE REQUIRED, GENERAL CONTRACTOR TO BE RESPONSIBLE FOR COORDINATING

ELECTRICAL AND MECHANICAL WORK TO MEET THIS REQUIREMENT, TYP. AND CONFIRM LOCATIONS WITH ARCHITECT PRIOR TO INSTALL. 24. CONTRACTOR TO COORDINATE **PLUMBING** LOCATIONS AND INSTALL ELEVATIONS TO ENSURE REQUIRED CLEARANCES.

25. PROVIDE OVERFLOW SCUPPERS FOR ALL FLAT ROOF AND ROOF DECK AREAS, LOCATIONS AS INDICATED ON THE ELEVATION DRAWINGS.

26. IN CASE OF DISCREPANCY BETWEEN MECHANICAL & ARCHITECTURAL DRAWINGS REGARDING VENT SIZES, FINISHEDS AND LOCATION, ARCHITECTURAL SHALL GOVERN.

27. ALL **EXPOSED CONCRETE** TO HAVE 90 DEGREE CORNERS, NO CHAMFER.

28. PAINT FINISH FOR ALL FLASHINGS AND BREAKSHAPES TO MATCH FINISH SURFACE COLOR.

29. STAIR GUARDRAIL DIMENSIONS PROVIDED FOR INFORMATION ONLY. DIMENSIONS TO BE CONFIRMED ON SITE PRIOR TO FABRICATION.

30. ALL GUARDS TO BE ENGINEERED BY FABRICATOR & SHOP DRAWINGS SUBMITTED FOR REVIEW & APPROVAL PRIOR TO FABRICATION. 31. ALL GRADING SHOWN TO BE FINISHED GRADE. ROUGH GRADE IS TO KEPT 150MM DOWN FOR PLACEMENT OF TOPSOIL BY OTHERS IN THOSE AREAS WITHOUT HARD SURFACES U.N.O.

REFER TO CIVIL & LANDSCAPE DRAWINGS. 32. GRADE TO DESIGN SPOT ELEVATIONS INDICATED. ALL GROUND PLANES AND SWALES TO BE SMOOTH AND TRUE PROVIDING POSITIVE DRAINAGE AND PREVENT ANY PONDING OF

WATER. GRADE AT BUILDING TO BE SLOPED AWAY AT A MINIMUM SLOPE OF 2%. REFER TO CIVIL & LANDSCAPE DRAWINGS.

33. CONTRACTOR TO COORDINATE ANY CITY OF VANCOUVER REQUIRED UPGRADES OR OFF-SITE WORK.

34. CONTRACTOR TO COORDINATE ANY WORK OF OWNER SUPPLIED ITEMS AND/ OR INSTALLATION WORK BY CONTRACTOR OUTSIDE THE GENERAL CONTRACT

35. 3D IMAGES PROVIDED FOR REFERENCE ONLY, DO NOT BUILD FROM 3D IMAGES PROVIDED.

PROJECT STATISTICS SITE DATA LEGAL DESCRIPTION UBC Applied Science Digital Design Studio CIVIC ADDRESS 2360 East Mall, Vancouver, BC V6T 1Z3 ZONING **EXISTING ZONING** N/A N/A PROPOSED ZONING MAXIMUM FSR SITE AREA 500m² PROJECT DATA PERMITTED PROPOSED **BUILDING HEIGHT** 12.2m **BUILDING HEIGHT** SITE COVERAGE 500m² SETBACKS NORTH SETBACK SOUTH SETBACK EAST SETBACK WEST SETBACK

MAX.

MECH.

MIN.

MTL.

N.I.C.

N/A

NO.

O.C.

O.D.

O.H.

OPP.

P.LAM

P.T.

PLY.

PTD.

R.B.

R.C.B.

R.D.

R.O.

R.W.L

REINF.

REQ.

REV.

S.A.M.

S.S.

SECT.

SHGC

SIM.

SPEC

STD.

STL.

STR.

T.O.

TYP.

U.N.O

U/S

VERT.

VIN

W/O

SQ.

OPN'G

MAXIMUM

MINIMUM

METAL

NUMBER

ON CENTRE

OVERHEAD

OPENING

OPPOSITE

PLATE

PLYWOOD

PAINTED

RUBBER BASE

ROOF DRAIN

REINFORCED

REQUIRED

REVERSE

SECTION

SIMILAR

SQUARE

STEEL

TOP OF

TYPICAL

UNDERSIDE

VERTICAL

WITHOUT

CHECKERED PLATE

VINYL

WITH

STANDARD

STRUCTURAL

UNLESS NOTED OTHERWISE

SPECIFICATION

ROUGH OPENING

STAINLESS STEEL

RUBBER COVE BASE

RAIN WATER LEADER

SELF ADHESIVE AIR/VAPOUR BARRIER MEMBRANE

SOLAR HEAT GAIN COEFFICIENT = G VALUE

MECHANICAL

NOT IN CONTRACT

NOT APPLICABLE


OVERFLOW DRAIN

PLASTIC LAMINATE

PRESSURE TREATED **POWDER COAT**

NOT TO SCALE

SYMBOLS LEGEND **ABBREVIATIONS** ANNO. DESCRIPTION A.F.F ABOVE FINISHED FLOOR A.P. **ACCESS PANEL** ADJ. **ADJUSTABLE** 150m2 ALUM. ALUMINUM CEILING TAG Ref: 1/ A101 ANOD. ANODIZED 1000 AFF ARC. **ARCHITECTURAL CURTAIN PANEL TAG** (GL#) B/B BACK TO BACK B/S **BOTH SIDES GRID LINE** DETAIL ITEM TYPE NAME BD. BOARD BLDG. BUILDING BLKG. BLOCKING DOOR TAG D-###-## BTM. BOTTOM **ELEVATION DATUM** C.B. CATCH BASIN FLOOR TAG C.G. **CORNER GUARD** C.I.P. CAST IN PLACE FLOOR FINISH TAG C.J. CONTROL JOINT C.O. **CONCRETE OPENING BUILDING ELEVATION KEYNOTE TAG** C/W **COMPLETE WITH** COL. COLUMN MATERIAL TAG CONC. CONCRETE CONT. CONTINUOUS CPT. CARPET CASEWORK TAG DIM. DIMENSION INTERIOR ELEVATION DN. DOWN 1i PARKING TAG DWG. DRAWING E.J. **EXPANSION JOINT** PLUMBING FIXTURE TAG E/S EACH SIDE **ELEVATION REVISION TAG** ELEC. **ELECTRICAL VIEW REFERENCE** EQ. **EQUAL ROOF TAG** EQUIP. **EQUIPMENT** EXP. **EXPOSED** F.D. FLOOR DRAIN **ROOM TAG** F.E. FIRE EXTINGUISHER **BUILDING SECTION** F.E.C. FIRE EXTINGUISHER CABINET SPECIALTY EQUIPMENT TAG F.F. FINISHED FLOOR FG **FIBREGLASS** 20 R @180mm STAIR #1 FINISH FLR. **FLOOR** WALL SECTION FPR FIRE PROTECTION RATING FR GL FROSTED GLASS FRR FIRE RESISTANCE RATING **WINDOW TAG** G.B. GYPSUM BOARD GAUGE SPOT ELEVATION - EXISTING GALV. GALVANIZED ENLARGED PLAN/ SECTION DETAIL GL. GLASS SPOT ELEVATION - TARGET H.B. HOSE BIBB H.S.S. HOLLOW STEEL SECTION CENTRE LINE HOR. **HORIZONTAL** DETAIL CALLOUT I.D. **INSIDE DIAMETER** INSUL. INSULATION LG. LONG LOC. LOCATION M.O. MASONRY OPENING

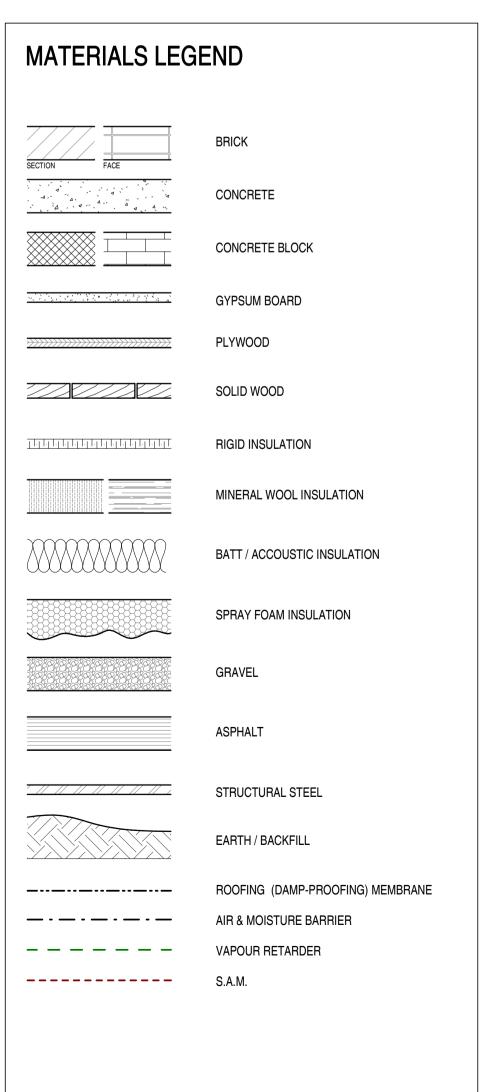


Architecture Inc.

1462 WEST 7th AVENUE VANCOUVER, BC CANADA EMAIL: info@shapearchitecture.ca WEB: www.shapearchitecture.ca

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NOTES

DESCRIPTION

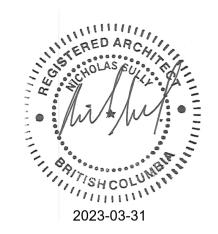REVISIONS

NO DESCRIPTION 1 Issued for Development Permit DATE

UBC Applied Science Digital Design Studio

2360 East Mall, Vancouver, BC V6T 1Z3

Issued for Development Permit

PROJECT DATA, NOTES, **SYMBOLS, ABBREVIATIONS**

March 31 2023 DATE DRAWN BY CHECKED BY AT/NS SCALE 2209



General Notes

- For site survey information refer to topographic survey plan of District lot 4805, group 1, New Westminster District except portions in Plan 9301, statutory right of way ex-plan 20570, part subdivided by plan BCP3309 and part subdivided by plan BCP30252 by Aplin & Martin Geomatics land surveying LTD on October 14, 2022
- 2. UBC CHBE will remain open for the duration of construction. Contractor to coordinate construction phasing plan with owner to minimize disruptions to existing operations.
- 3. Contractor to provide a minimum of 48 hours notice to owner in advance of any service interruptions.
- 4. Refer to civil drawings for full extent of off-site removals and improvements.
- 5. All off-site civil work to meet UBC Engineering standards and requirements.
- 6. All temporary site works to be removed and decommissioned following transition to permanent service connections.

CONTEXT LEGEND

Expansion

Existing Building

Legal Address DL 4805 Group 1 NWD

Civic Address 2360 East Mall, Vancouver, BC V6T 1Z3

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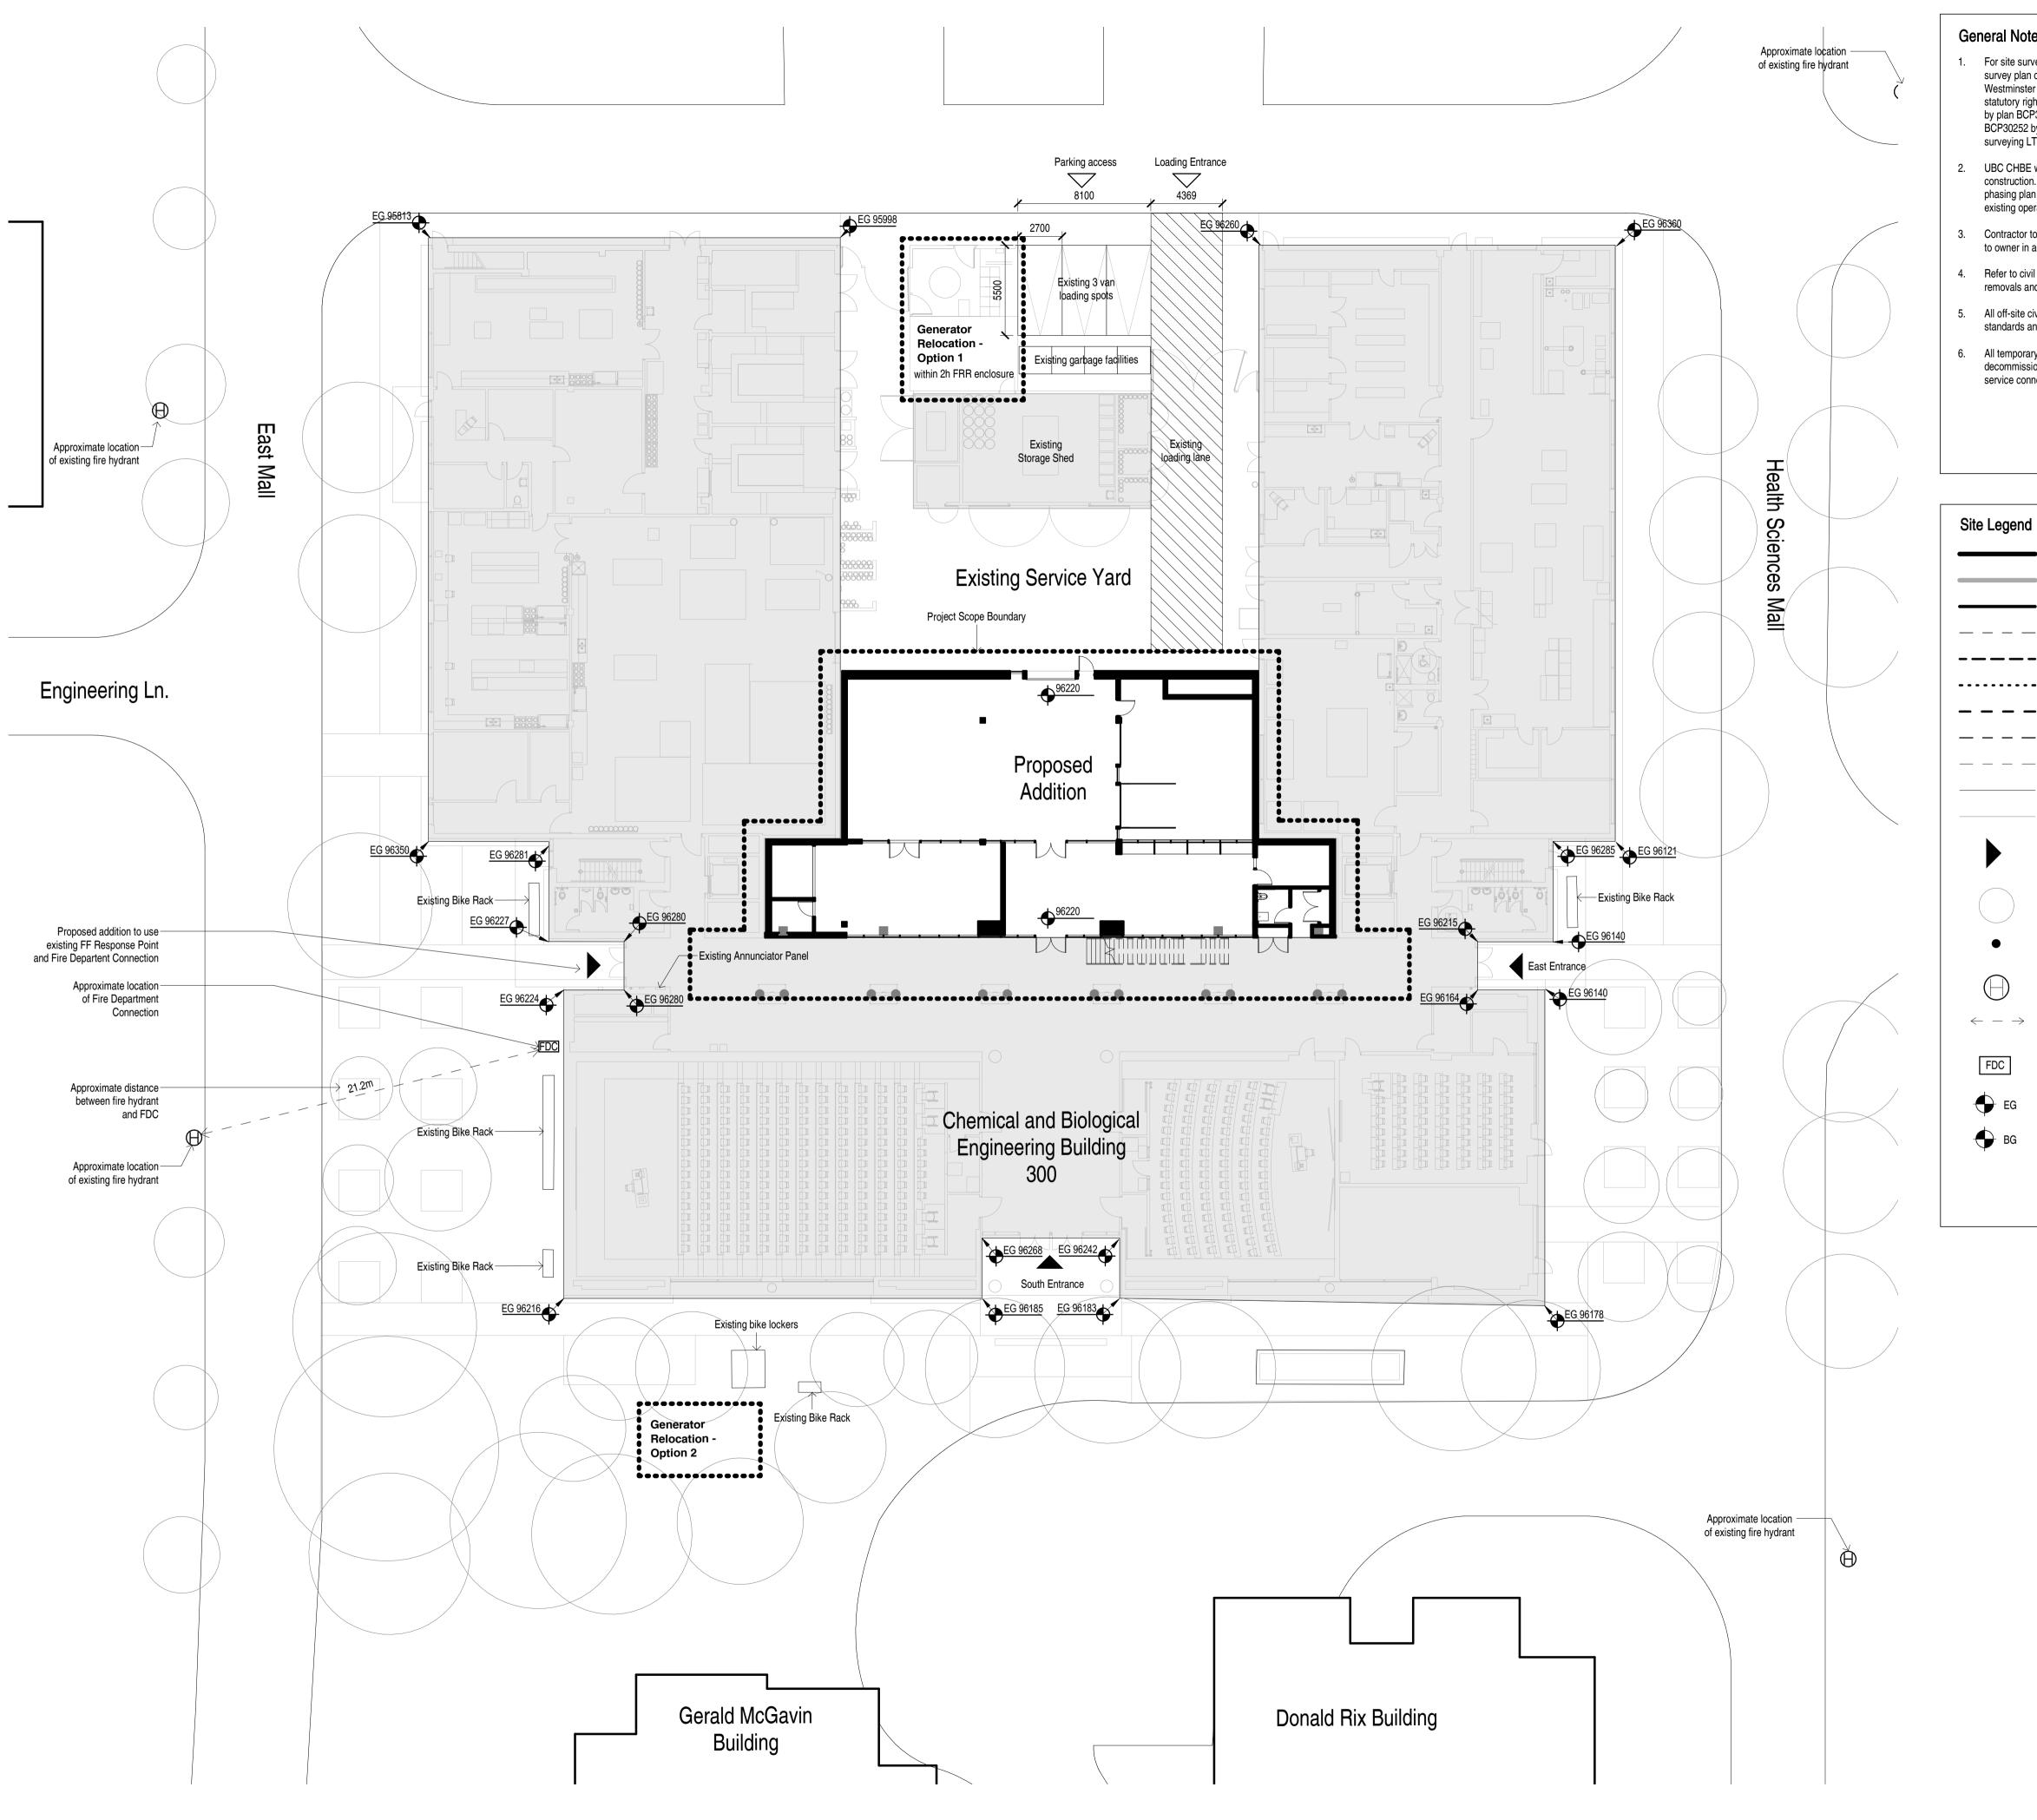
UBC Applied Science Digital Design Studio

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Context Plan

DATE March 31 2023 DRAWN BY AT/NS CHECKED BY SCALE As indicated 2209



General Notes

- 1. For site survey information refer to topographic survey plan of District lot 4805, group 1, New Westminster District except portions in Plan 9301, statutory right of way ex-plan 20570, part subdivided by plan BCP3309 and part subdivided by plan BCP30252 by Aplin & Martin Geomatics land surveying LTD on October 14, 2022
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- 4. Refer to civil drawings for full extent of off-site removals and improvements.
- 5. All off-site civil work to meet UBC Engineering standards and requirements.
- 6. All temporary site works to be removed and decommissioned following transition to permanent service connections.

Proposed Building **Existing Building** Property Line Setback Line Scope Boundary Line FF Access Route Overhead Line Sub-grade Services At Grade Services Landscape Lines **Building Entrance Existing Trees** Street Lights Fire Hydrant Unobstructed distance from fire hydrant to FDC FDC Siamese Connection Existing Grade Spot Elevation **Building Grade Spot Elevation**

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DATE 230331


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Site Plan

DATE March 31 2023 DRAWN BY CHECKED BY AT/NS SCALE As indicated 2209 JOB NUMBER





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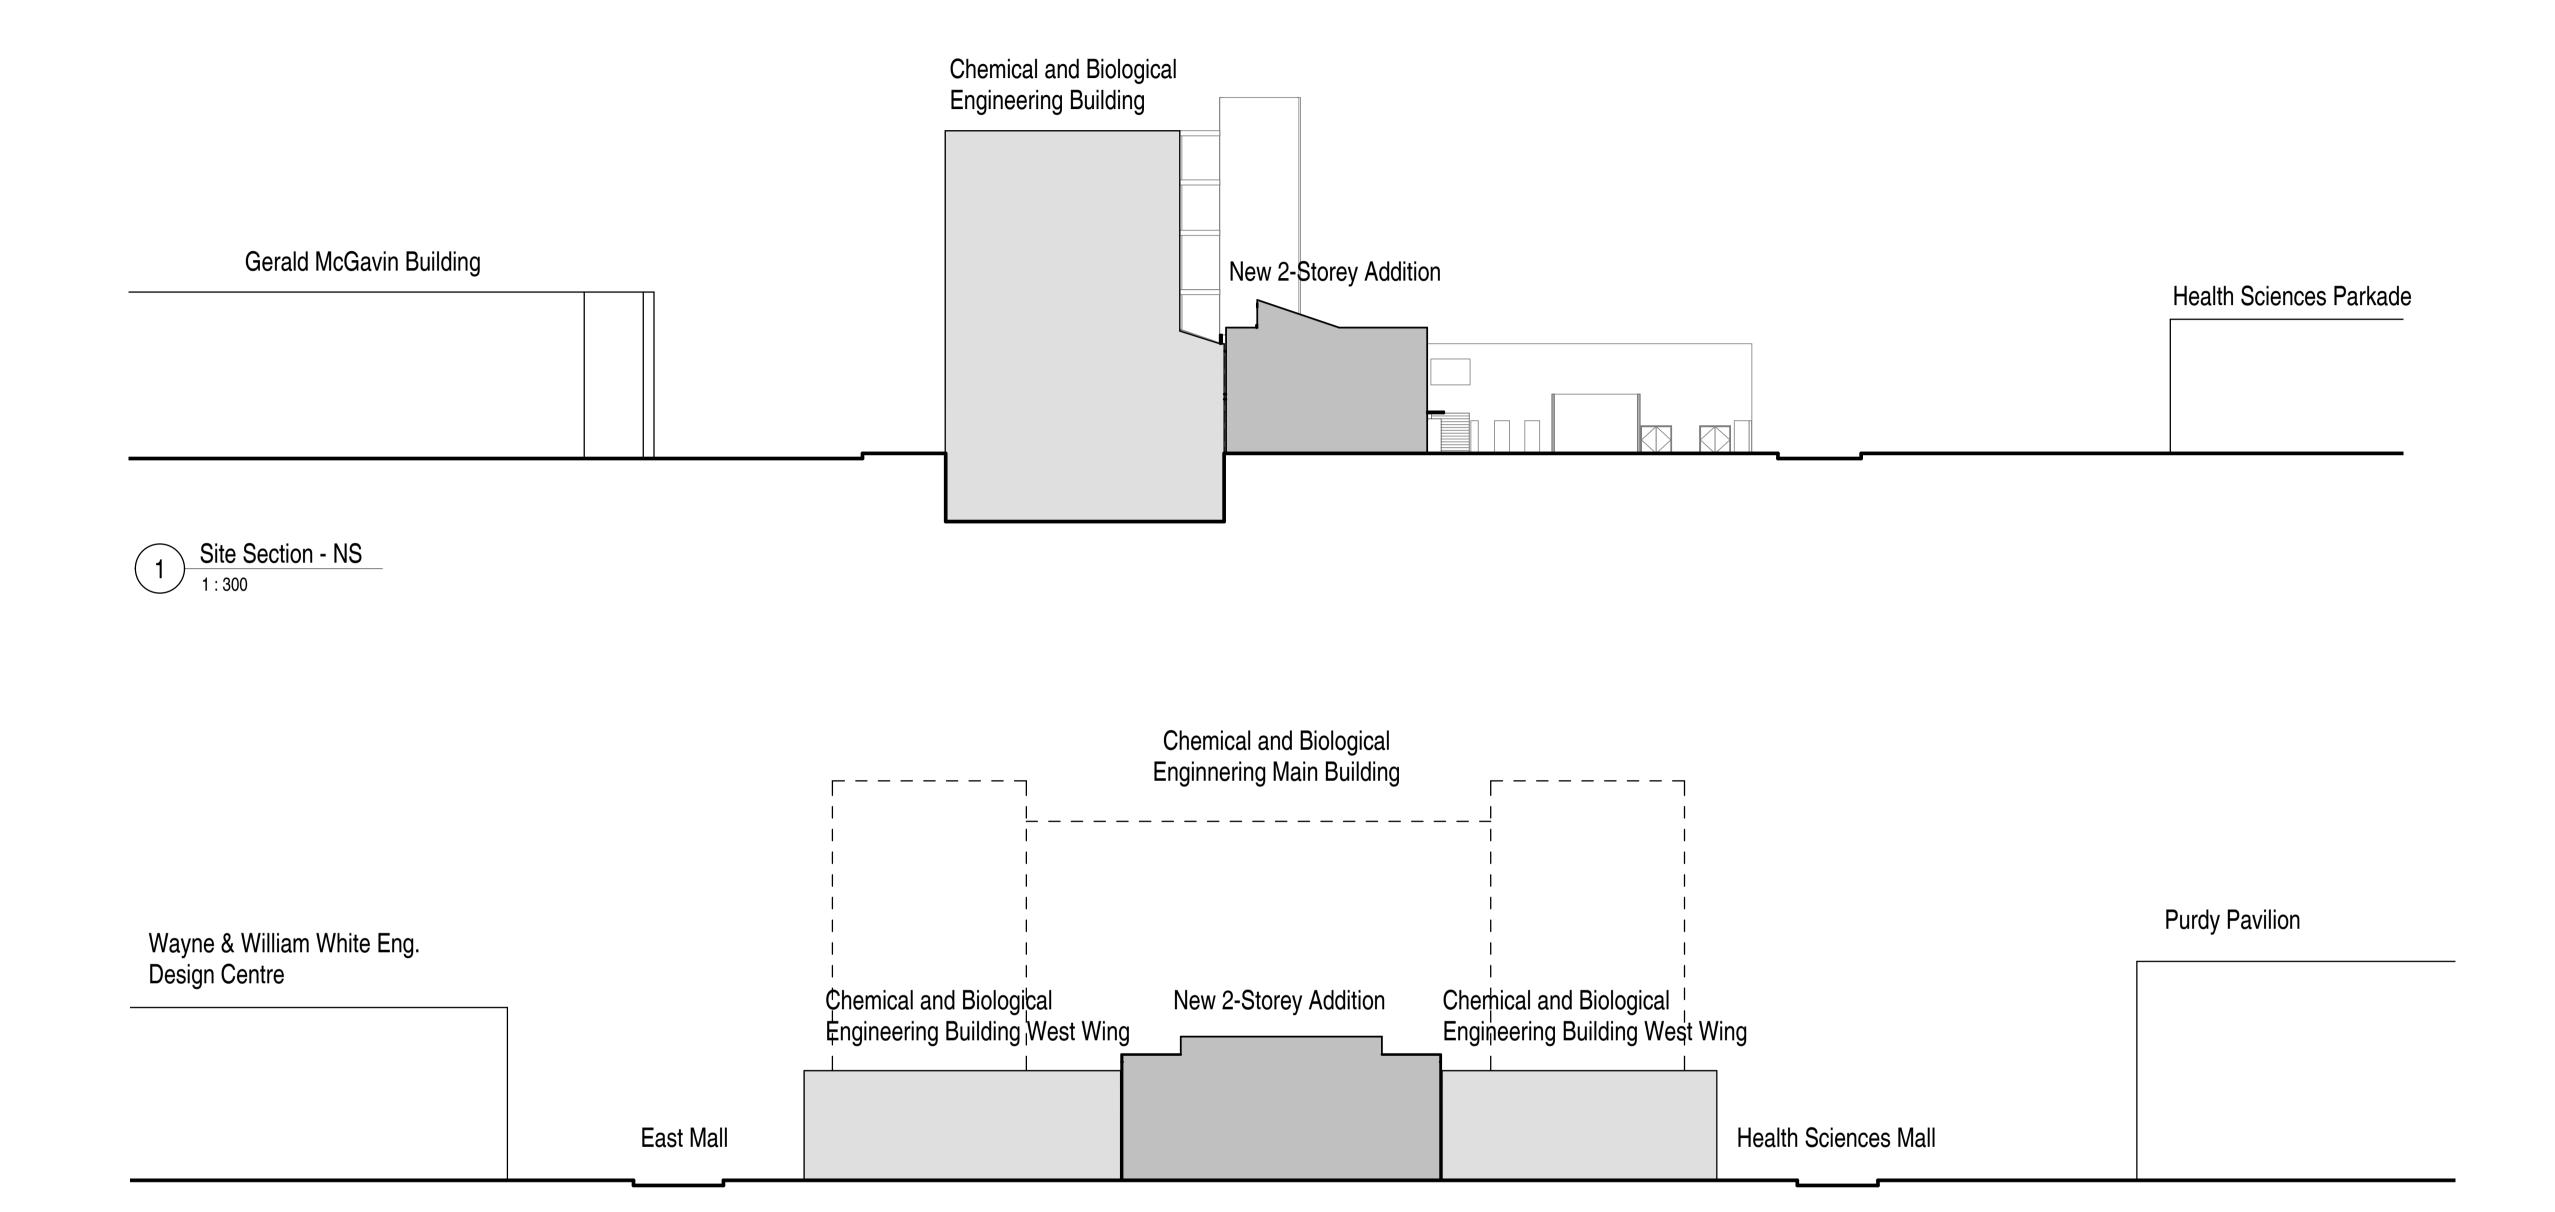
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Survey

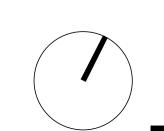_		
	DATE	March 31 2023
	DRAWN BY	WF
	CHECKED BY	AT/NS
	SCALE	1:400
	JOB NUMBER	2209



Site Section - EW
1:300

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Site Sections

DATE	March 31 2023
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SCALE	1:300
	2000
JOB NUMBER	2209

A015




Equinox @ 10am 1:2000




Summer Solstice @ 10am



Winter Solstice @ 10am 1:2000

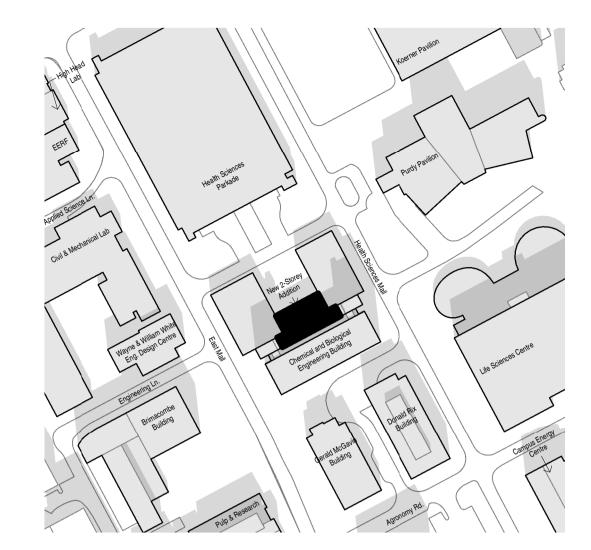


Equinox @ 12pm 1:2000

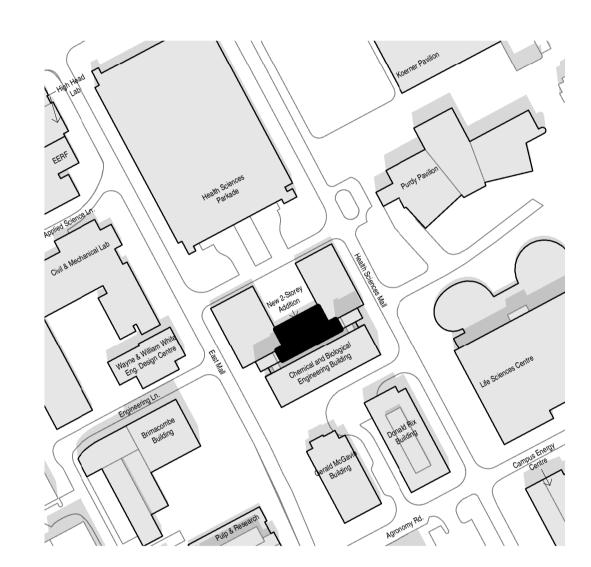


Summer Solstice @ 12pm



Winter Solstice @ 12pm

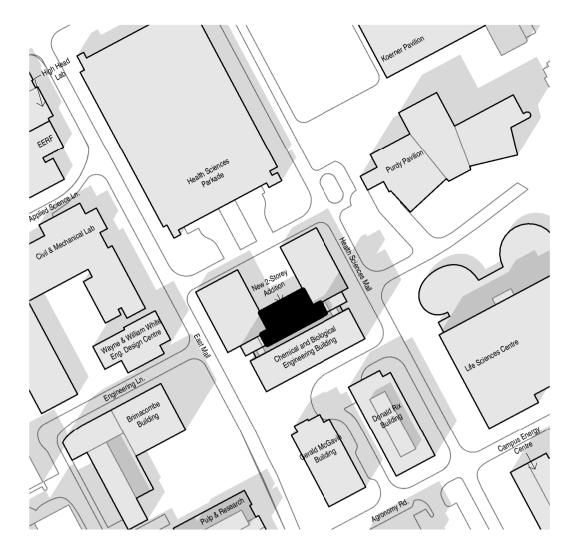

Equinox @ 2pm 1:2000

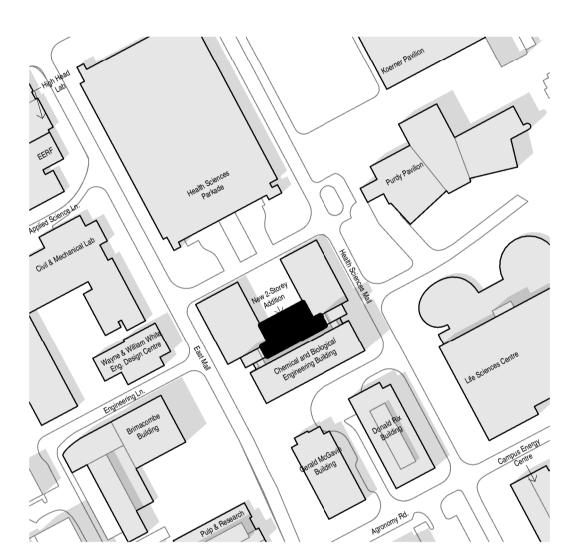

Summer Solstice @ 2pm



Winter Solstice @ 2pm

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Shadow Analysis

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- 1. Refer to wall schedule and wall sections and details for exterior wall stud types. 2. All washroom to meet accessibility standards
- outlined in the BCBC 2018. 3. Grab bars shall confirm to BCBC 2018 Articles
- 3.7.2.8 and 3.7.2.10. 4. Provide solid blocking in walls for all wall mounted fixtures, millwork, door stop and electrical equipment. Provide wall blocking on all walls within electrical and communications rooms. Water fountains to have waterresistant

solid backing.

- Refer to Electrical for all Lighting and Life Safety Equipment, and to Mechanical for all HVAC equipment, diffusers, grilles, and plumbing. Mechanical and Electrical systems are shown in 9. Architectural drawings for information only. Contractor to review and coordinate size and locations of all systems that are to be recessed
- 6. All elevator slab openings, door openings, pit size, and elevator mechanical room to be confirmed by elevator contractor.

into, or penetrate through, all, ceiling and floor


- All skylights to be tempered and laminated safety glass.
- All flashings to be counter-clipped. All roofing to comply with RCABC warranty requirements as specified.
- Design, supply and install fall restraint anchors to facilitate maintenance work on roof to Worksafe BC standards as specified. Final prior to installation.
- penetrations, and at wall connections with floor slabs above and below. 12. Provide shims and engineered supports for

11. For all acoustic partition walls, provide acoustic

sealant at all mechanical and electrical

glazing components as req'd.

13. Provide engineered lateral bracing for all

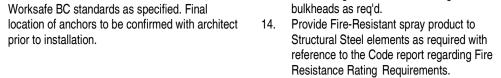

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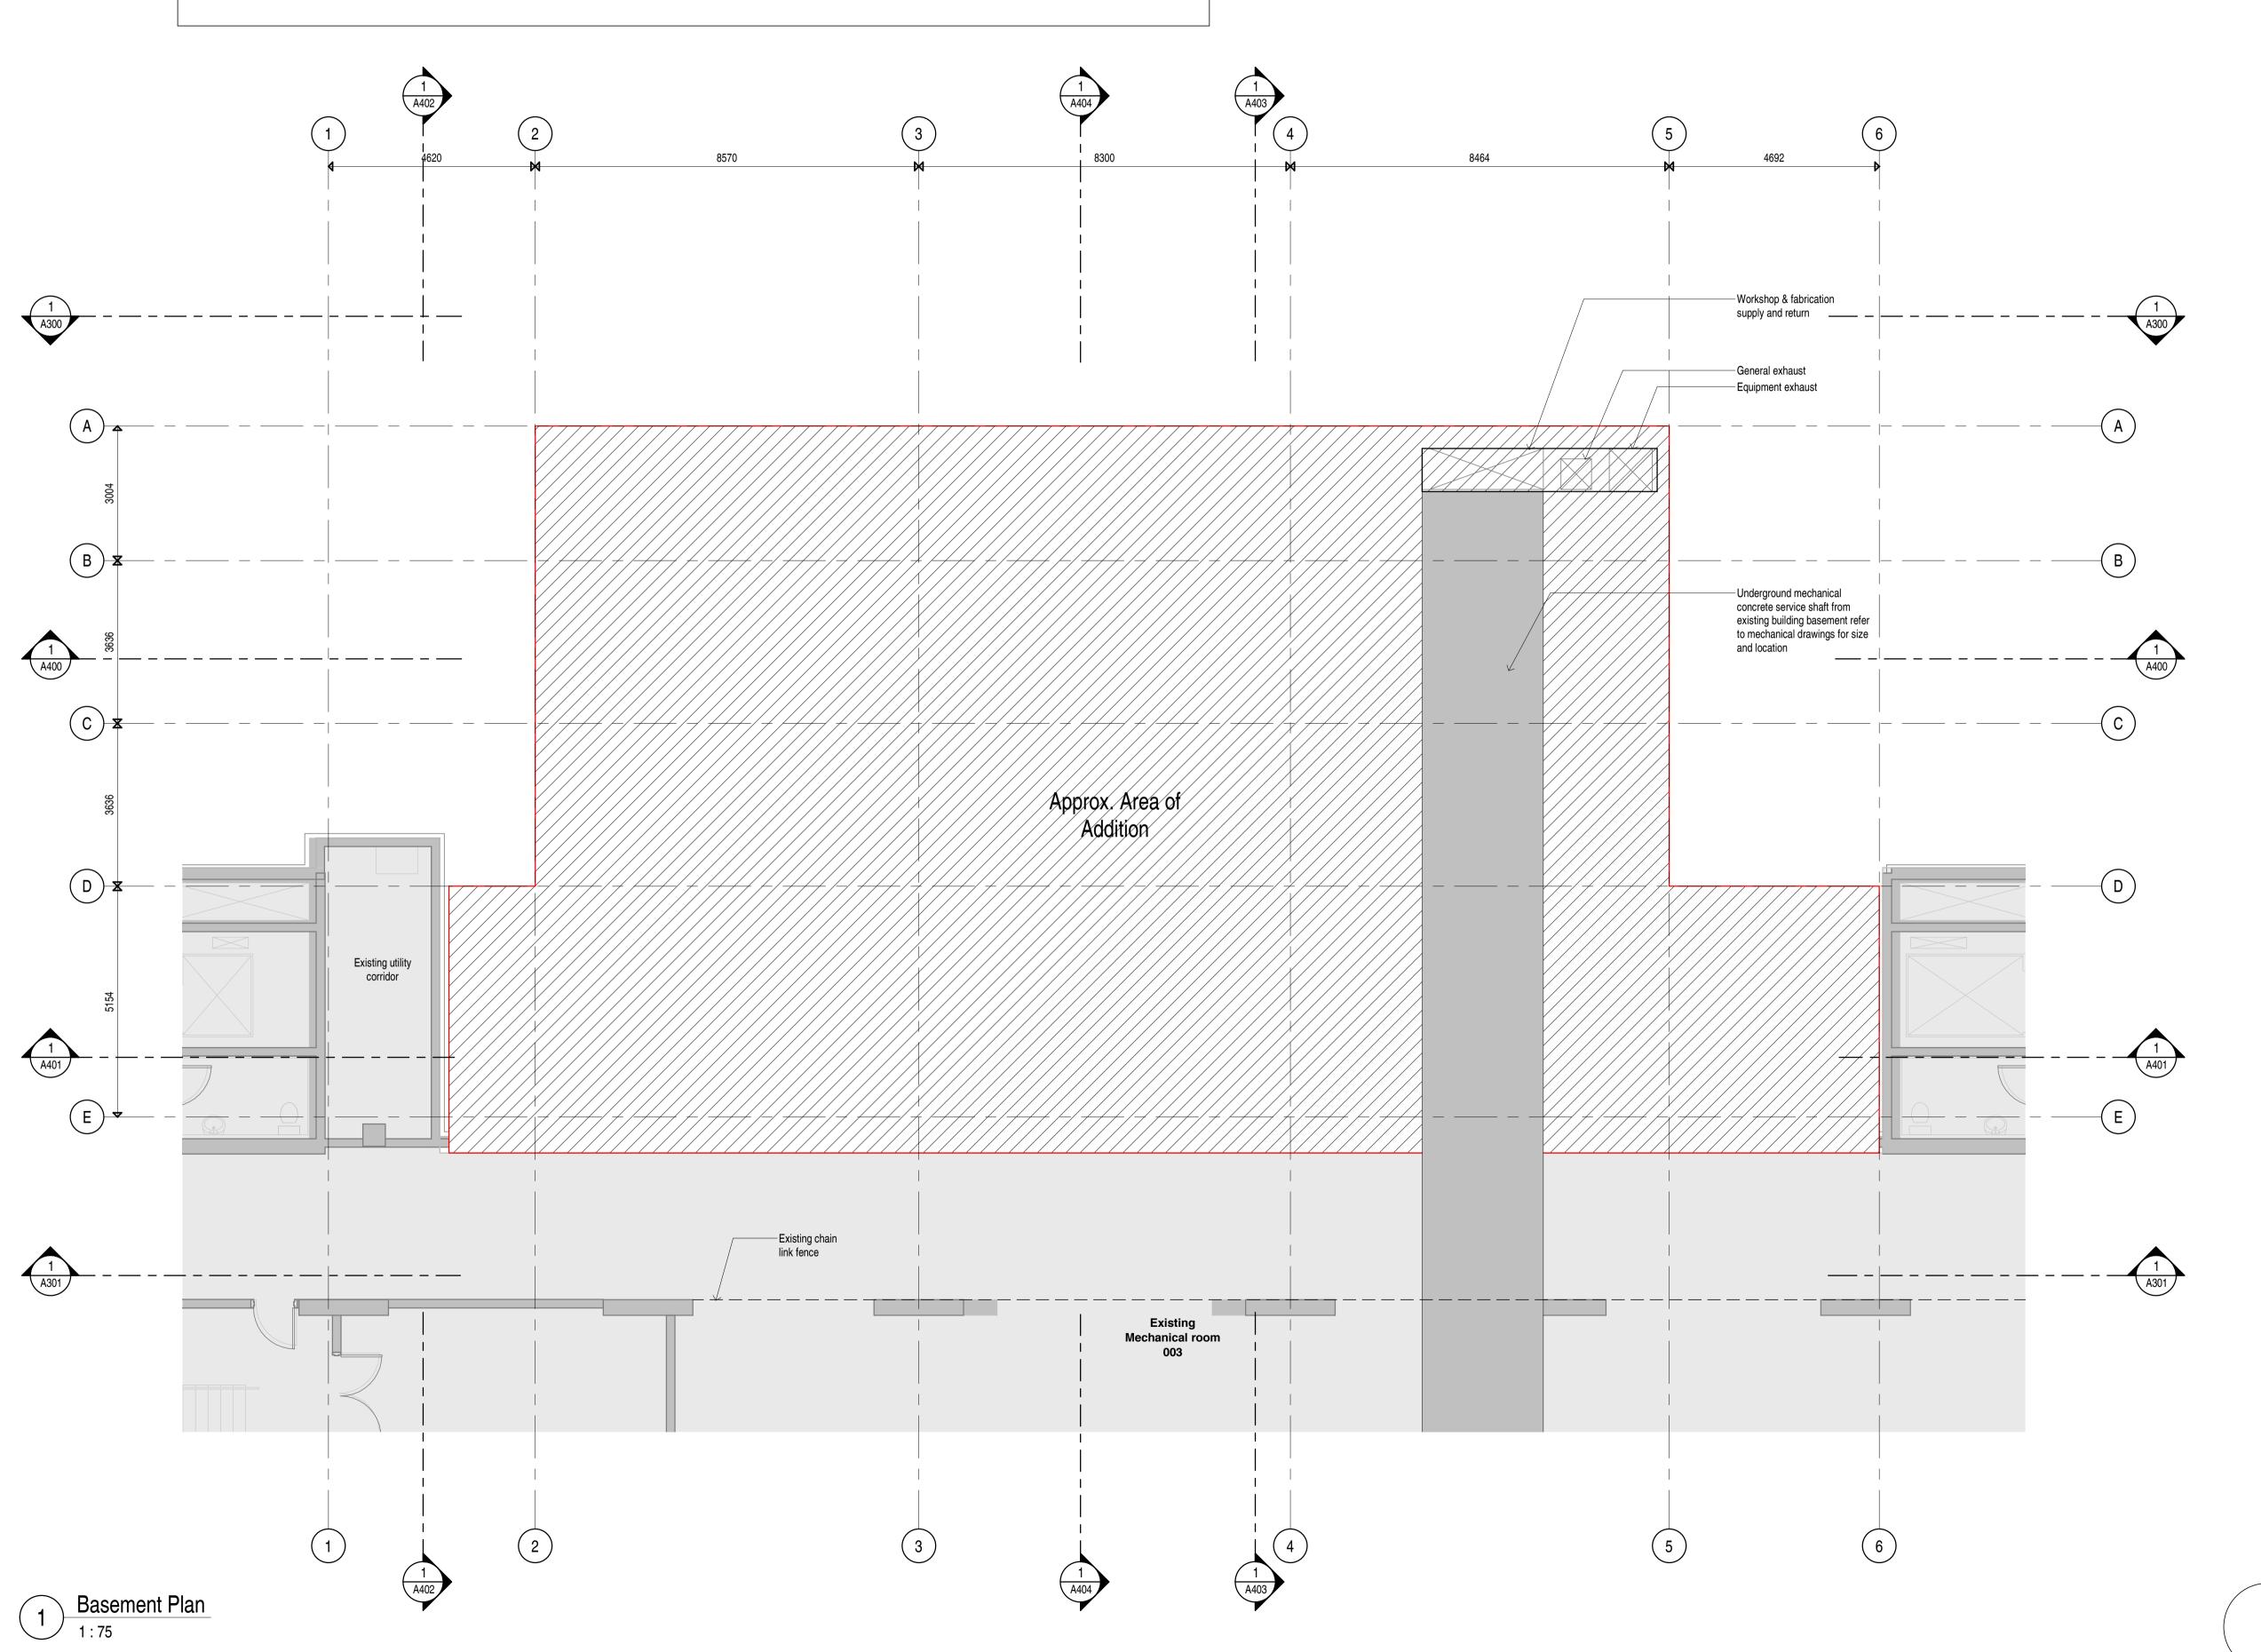
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Floor Plan Basement

March 31 2023 DRAWN BY CHECKED BY SCALE As indicated

JOB NUMBER



- 1. Refer to wall schedule and wall sections and details for exterior wall stud types. 2. All washroom to meet accessibility standards
- outlined in the BCBC 2018. 3. Grab bars shall confirm to BCBC 2018 Articles
- 3.7.2.8 and 3.7.2.10. 4. Provide solid blocking in walls for all wall mounted fixtures, millwork, door stop and electrical equipment. Provide wall blocking on all

solid backing.

walls within electrical and communications

rooms. Water fountains to have waterresistant

- Refer to Electrical for all Lighting and Life Safety Equipment, and to Mechanical for all HVAC equipment, diffusers, grilles, and plumbing. Mechanical and Electrical systems are shown in 9. Architectural drawings for information only. Contractor to review and coordinate size and locations of all systems that are to be recessed into, or penetrate through, all, ceiling and floor
- All elevator slab openings, door openings, pit size, and elevator mechanical room to be confirmed by elevator contractor.
- All skylights to be tempered and laminated safety glass.
- All flashings to be counter-clipped. All roofing to comply with RCABC warranty requirements as specified.
- Design, supply and install fall restraint anchors to facilitate maintenance work on roof to Worksafe BC standards as specified. Final prior to installation.
- 11. For all acoustic partition walls, provide acoustic sealant at all mechanical and electrical penetrations, and at wall connections with floor slabs above and below.
- 12. Provide shims and engineered supports for
- glazing components as req'd.


 13. Provide engineered lateral bracing for all bulkheads as req'd.
- location of anchors to be confirmed with architect 14. Provide Fire-Resistant spray product to Structural Steel elements as required with reference to the Code report regarding Fire Resistance Rating Requirements.

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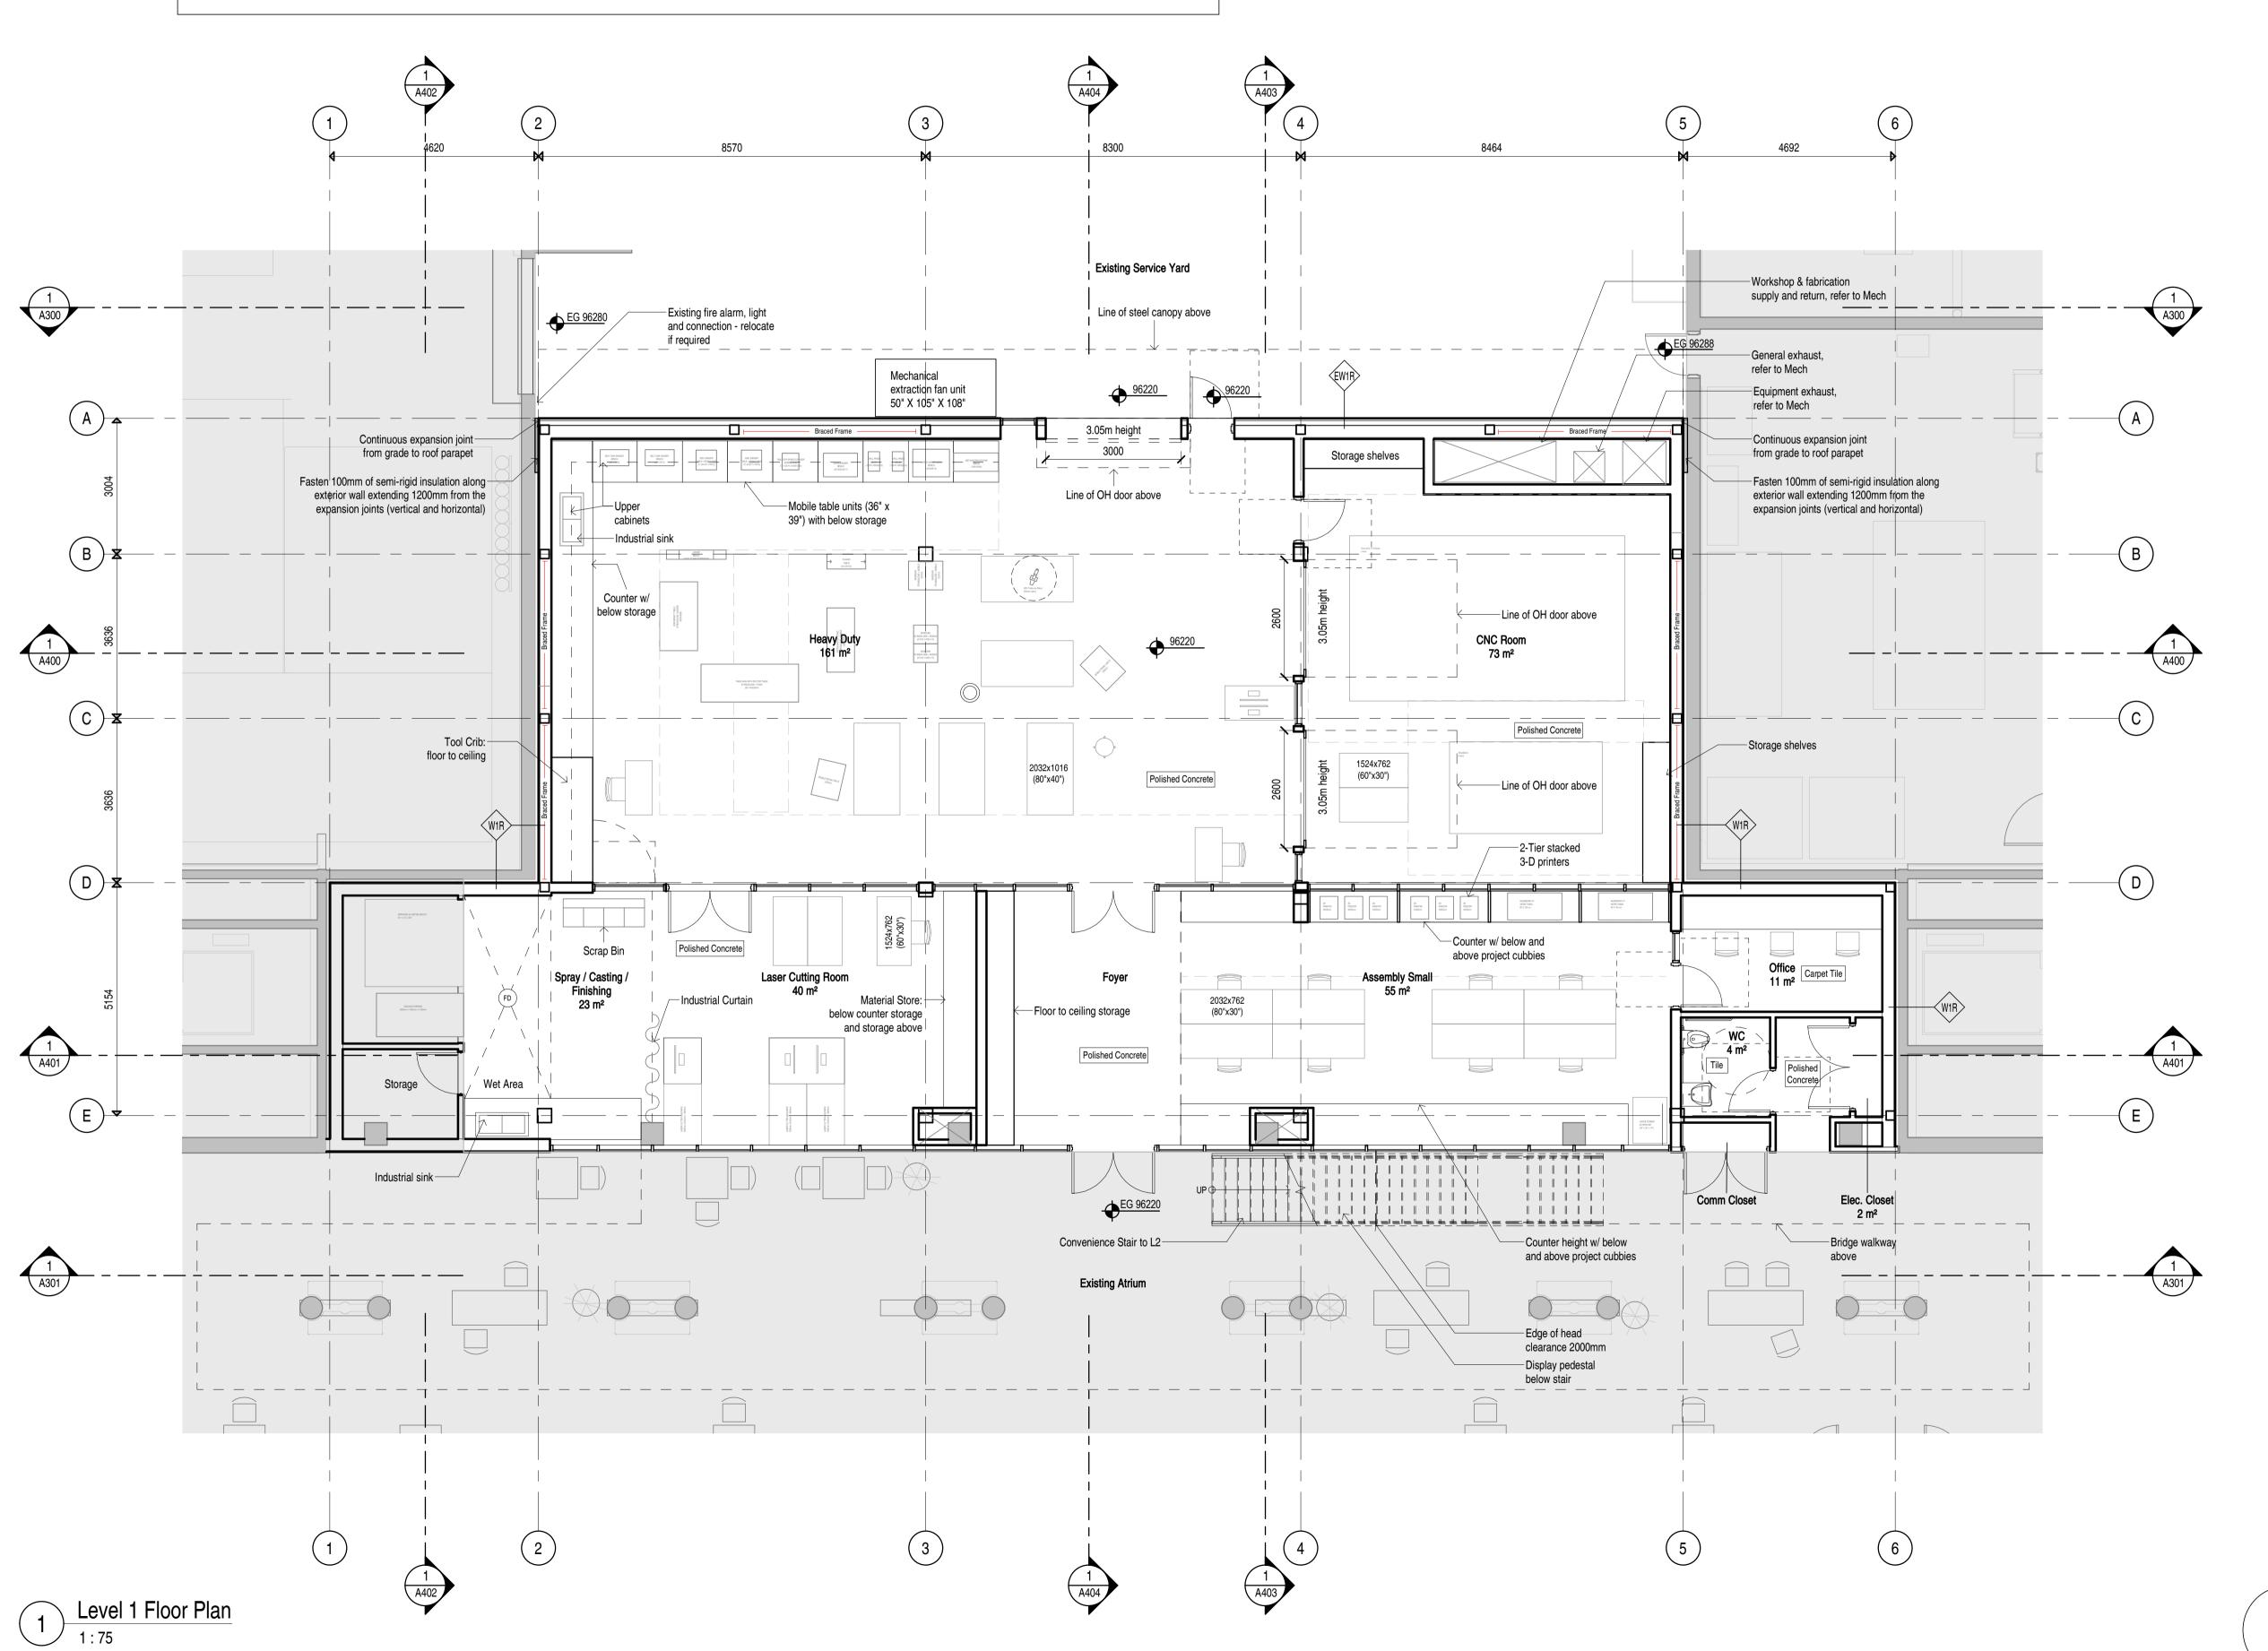
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Floor Plan L1

DATE March 31 2023 DRAWN BY WF CHECKED BY AT/NS SCALE As indicated	
CHECKED BY AT/NS	March 31 2023
*	WF
SCALE As indicated	AT/NS
	As indicated

JOB NUMBER



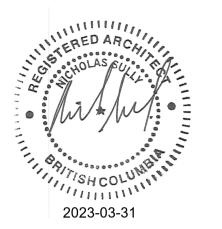

- 1. Refer to wall schedule and wall sections and details for exterior wall stud types.
- 2. All washroom to meet accessibility standards outlined in the BCBC 2018. 3. Grab bars shall confirm to BCBC 2018 Articles
- 3.7.2.8 and 3.7.2.10. 4. Provide solid blocking in walls for all wall
- mounted fixtures, millwork, door stop and electrical equipment. Provide wall blocking on all walls within electrical and communications rooms. Water fountains to have waterresistant solid backing.
- Refer to Electrical for all Lighting and Life Safety Equipment, and to Mechanical for all HVAC equipment, diffusers, grilles, and plumbing. Mechanical and Electrical systems are shown in 9. Architectural drawings for information only.

6. All elevator slab openings, door openings, pit

size, and elevator mechanical room to be

into, or penetrate through, all, ceiling and floor

- All flashings to be counter-clipped. All roofing to comply with RCABC warranty Contractor to review and coordinate size and locations of all systems that are to be recessed
 - requirements as specified. Design, supply and install fall restraint anchors to facilitate maintenance work on roof to Worksafe BC standards as specified. Final location of anchors to be confirmed with architect 14. Provide Fire-Resistant spray product to prior to installation.

safety glass.

- All skylights to be tempered and laminated 11. For all acoustic partition walls, provide acoustic sealant at all mechanical and electrical penetrations, and at wall connections with floor slabs above and below.
 - 12. Provide shims and engineered supports for
 - glazing components as req'd.

 13. Provide engineered lateral bracing for all
 - bulkheads as req'd. Structural Steel elements as required with reference to the Code report regarding Fire Resistance Rating Requirements.

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NO DESCRIPTION 1 Issued for Development Permit

DATE 230331

UBC Applied Science Digital Design Studio


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Floor Plan L2

March 31 2023 DRAWN BY CHECKED BY AT/NS SCALE As indicated

JOB NUMBER



- 1. Refer to wall schedule and wall sections and details for exterior wall stud types. 2. All washroom to meet accessibility standards
- outlined in the BCBC 2018. 3. Grab bars shall confirm to BCBC 2018 Articles
- 3.7.2.8 and 3.7.2.10. 4. Provide solid blocking in walls for all wall mounted fixtures, millwork, door stop and electrical equipment. Provide wall blocking on all walls within electrical and communications

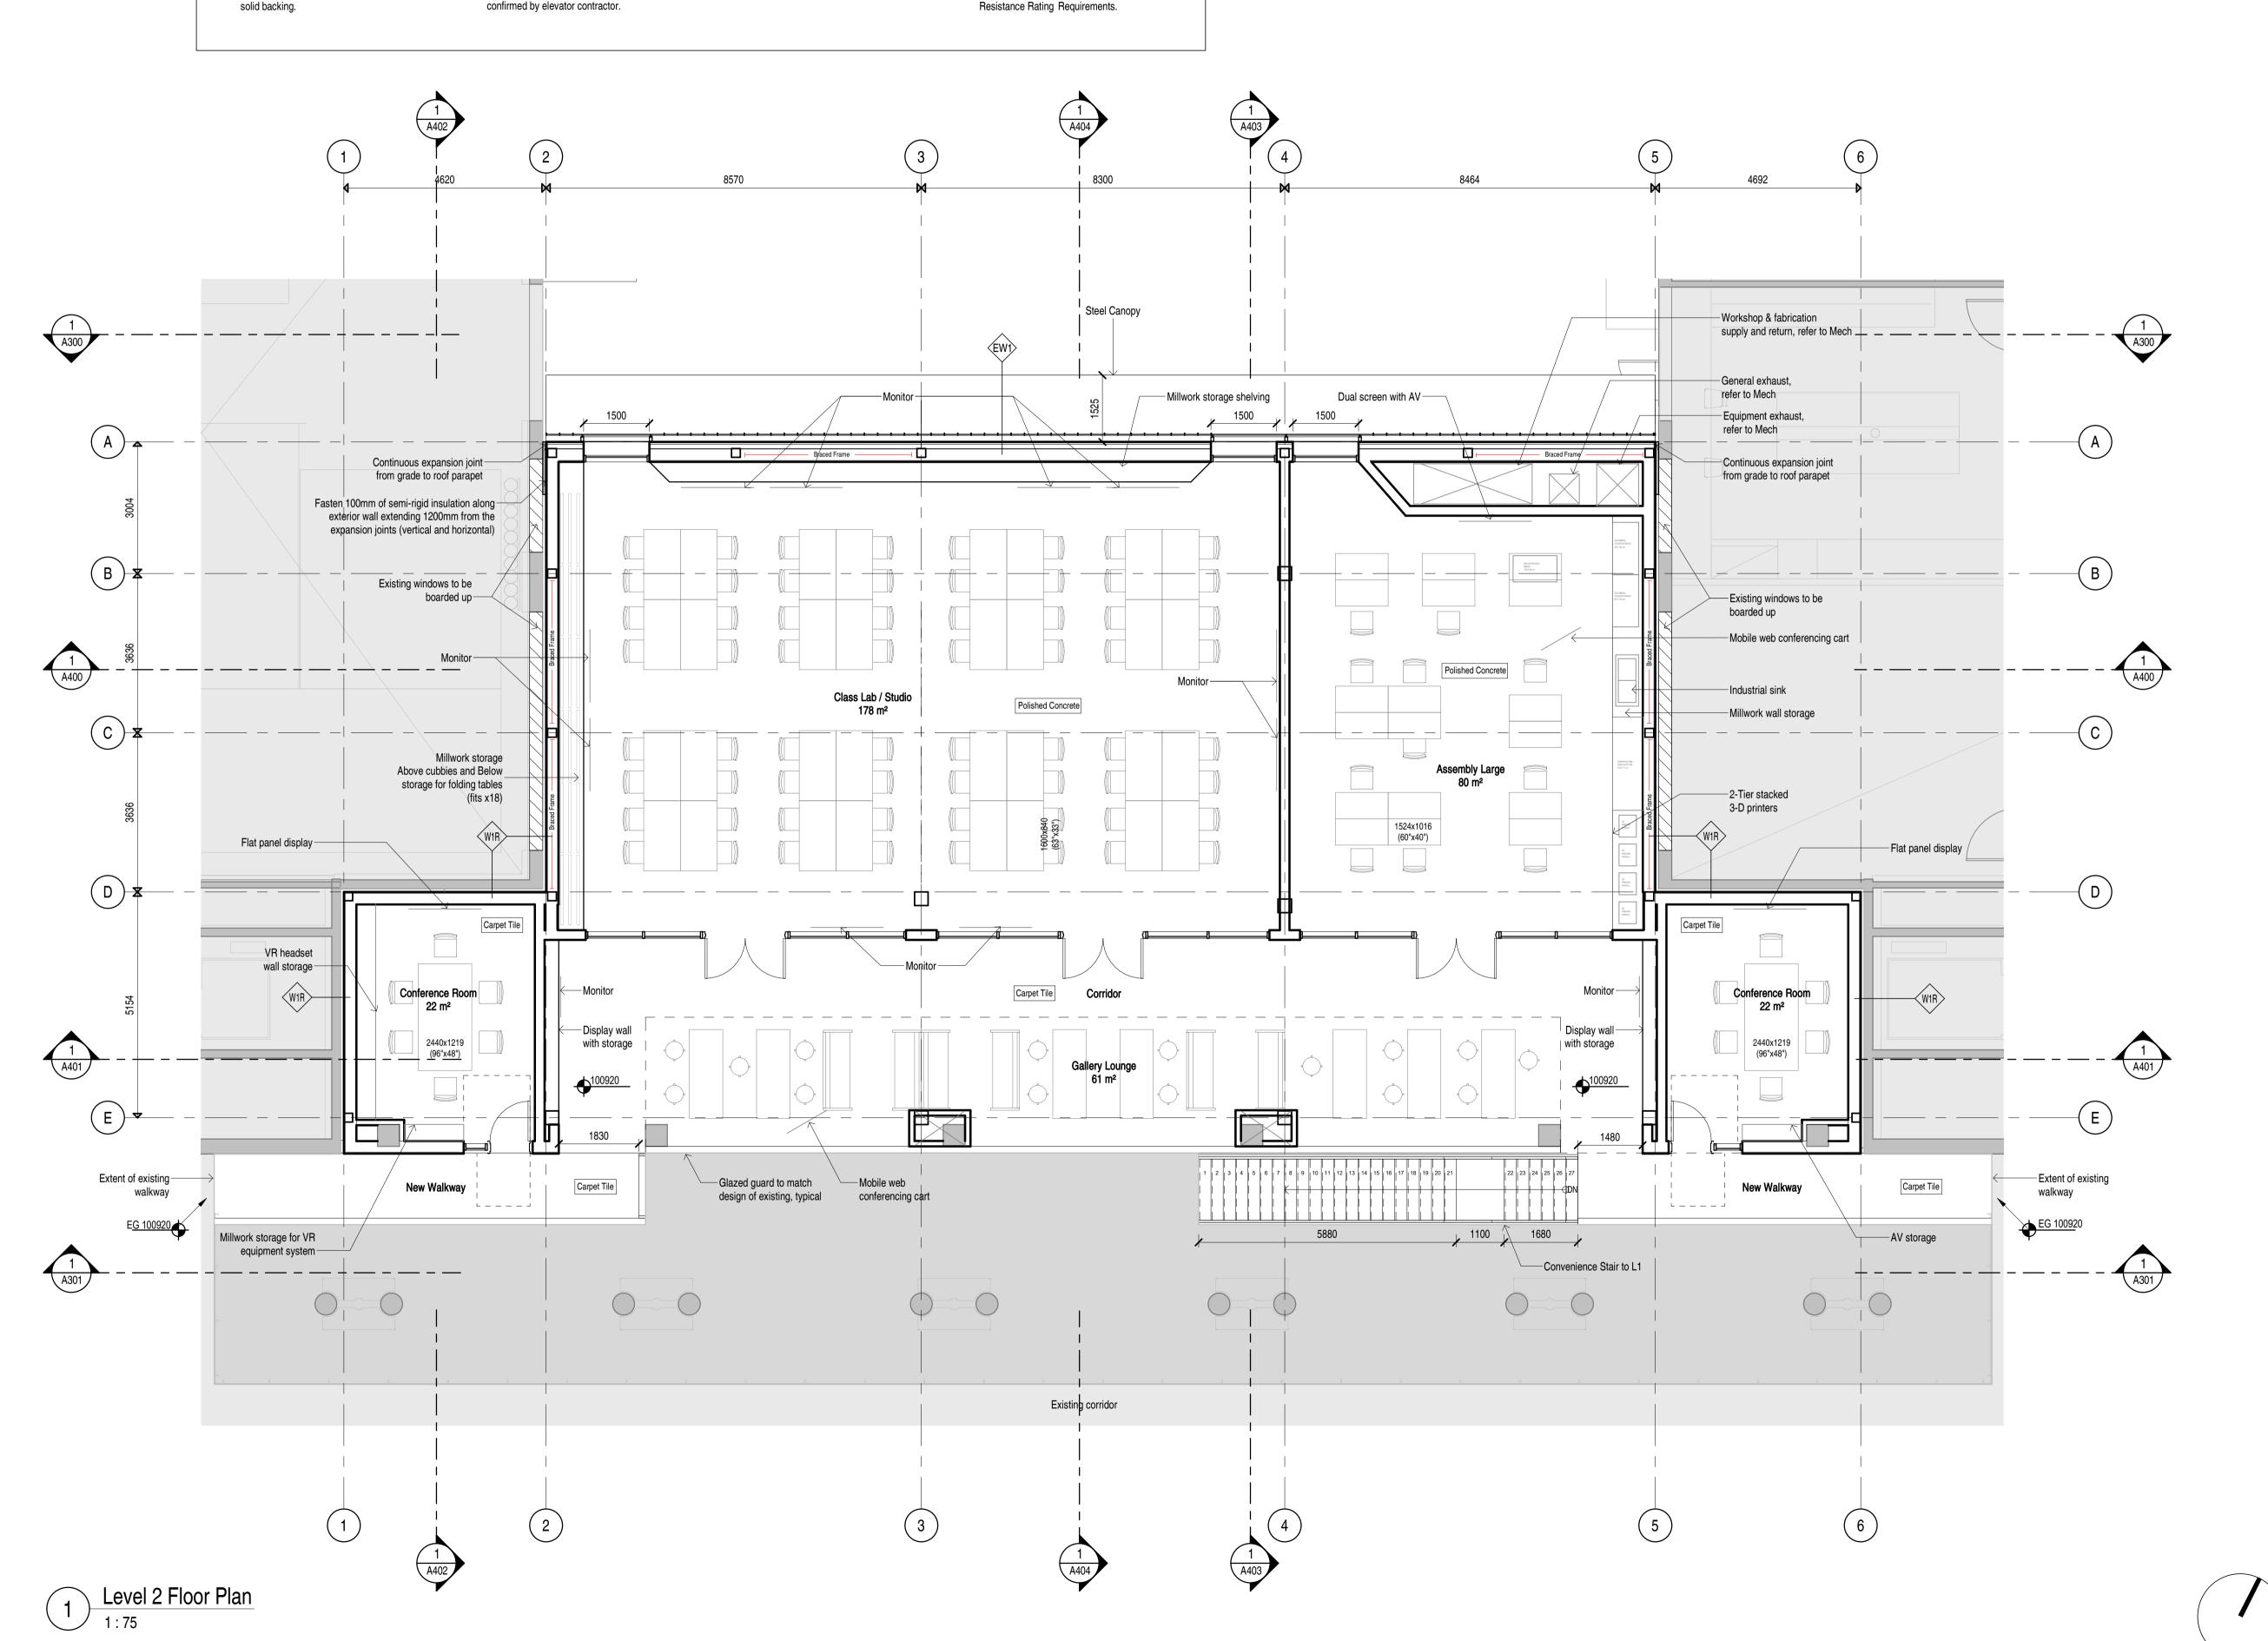rooms. Water fountains to have waterresistant

- Refer to Electrical for all Lighting and Life Safety Equipment, and to Mechanical for all HVAC equipment, diffusers, grilles, and plumbing. Mechanical and Electrical systems are shown in 9. Architectural drawings for information only. Contractor to review and coordinate size and locations of all systems that are to be recessed into, or penetrate through, all, ceiling and floor
- All elevator slab openings, door openings, pit size, and elevator mechanical room to be confirmed by elevator contractor.
- All skylights to be tempered and laminated safety glass.

prior to installation.

- All flashings to be counter-clipped. All roofing to comply with RCABC warranty
- requirements as specified. Design, supply and install fall restraint anchors to facilitate maintenance work on roof to Worksafe BC standards as specified. Final
- slabs above and below. 12. Provide shims and engineered supports for
 - glazing components as req'd.

 13. Provide engineered lateral bracing for all

11. For all acoustic partition walls, provide acoustic

sealant at all mechanical and electrical

penetrations, and at wall connections with floor


- bulkheads as req'd. Structural Steel elements as required with
- location of anchors to be confirmed with architect 14. Provide Fire-Resistant spray product to reference to the Code report regarding Fire Resistance Rating Requirements.

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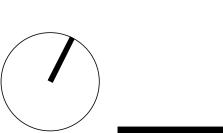
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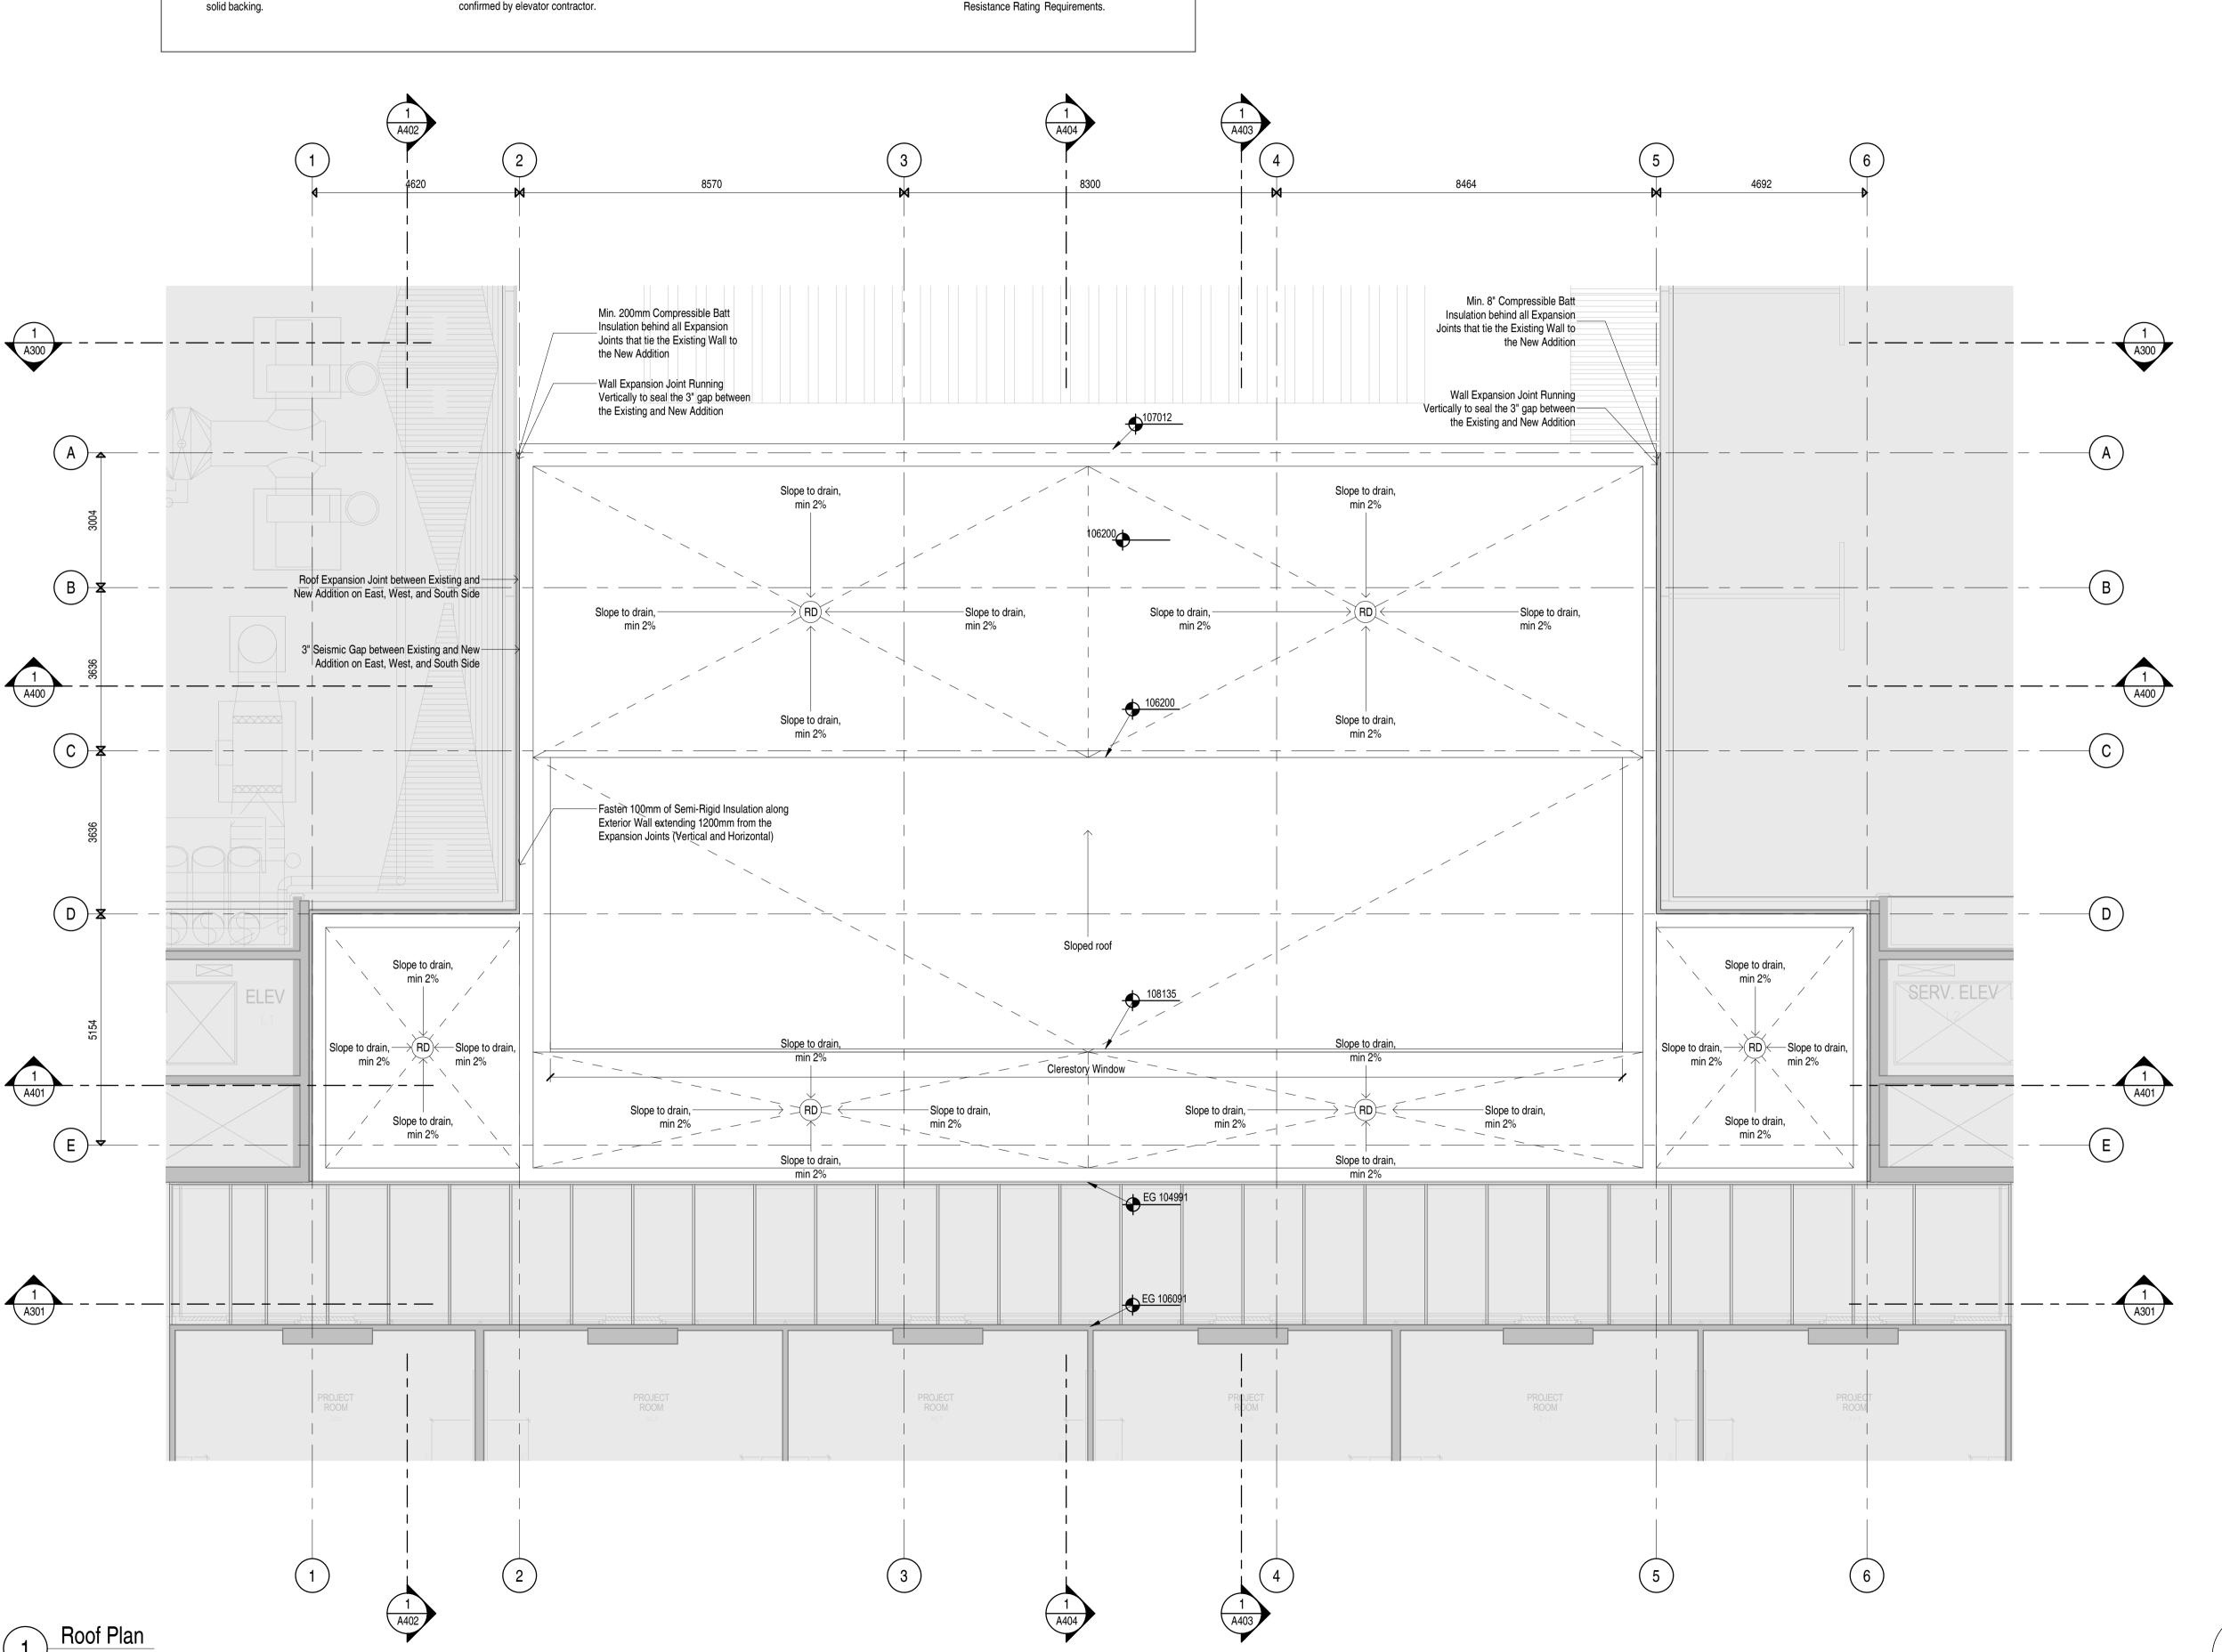
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Roof Plan

DATE	March 31 2023
DRAWN BY	WF
CHECKED BY	AT/NS
SCALE	As indicated

JOB NUMBER



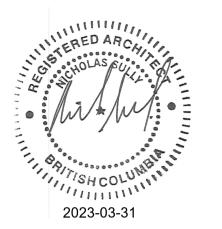

4692 8464 8300 8570 M08) M05) M06) M09 Roof beyond Roof Level 105620 Existing CHBE Building West Wing Existing CHBE Building East Wing Level 2 100920 Level 1 96220 Ceramic glass to achive required 2h FRR Mechanical Vertical mechanical extraction fan unit 50" X 105" X 108" louver, refer to mech Metal panel-Roll up door, 2h FRR Exit door to service yard, — 2h FRR 2 6 1 A404

Building Elevation North 1:75

General Notes - Elevation

- In case of discrepency between MECH. and ARCH. regarding Louvre sizes, ARCH shall govern
 Paint finish for all flashing, break shapes and metal cladding panels to be from custom colour range

Exterior Elevation Legend

M02

M03 Glass with fritt

M04 Architectural concrete

M05 Aluminum louvres

M06 Standing seam metal M07 Plywood sheathing

M08

Spandrel panel with shadow box

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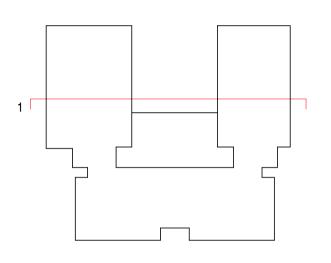
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Building Elevations

JOB NUMBER

March 31 2023 DRAWN BY CHECKED BY AT/NS SCALE As indicated 2209

General Notes - Elevation

- In case of discrepency between MECH. and ARCH. regarding Louvre sizes, ARCH shall govern
 Paint finish for all flashing, break shapes and metal cladding panels to be from custom colour range

Exterior Elevation Legend

M02

M03 Glass with fritt

M04 Architectural concrete

M05 Aluminum louvres

M06 Standing seam metal M07 Plywood sheathing

M08

Spandrel panel with shadow box

1 A404 8570 8300 4692 M03 M02 M01 M04 M02 M02 M01) M04 M01) M01) M02) M01) M02 M04) Roof beyond Existing beam to hold up skylight (ref to structural) Existing skylight — Line of existing demolished wall Roof Level Extent of Existing Extent of Existing Level 2 100920 /\ Sprinkler protected glazed to achieve 2h FRR

5

6

3

1 A404

1 Interior Elevation
1:75

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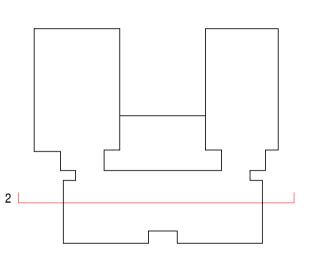
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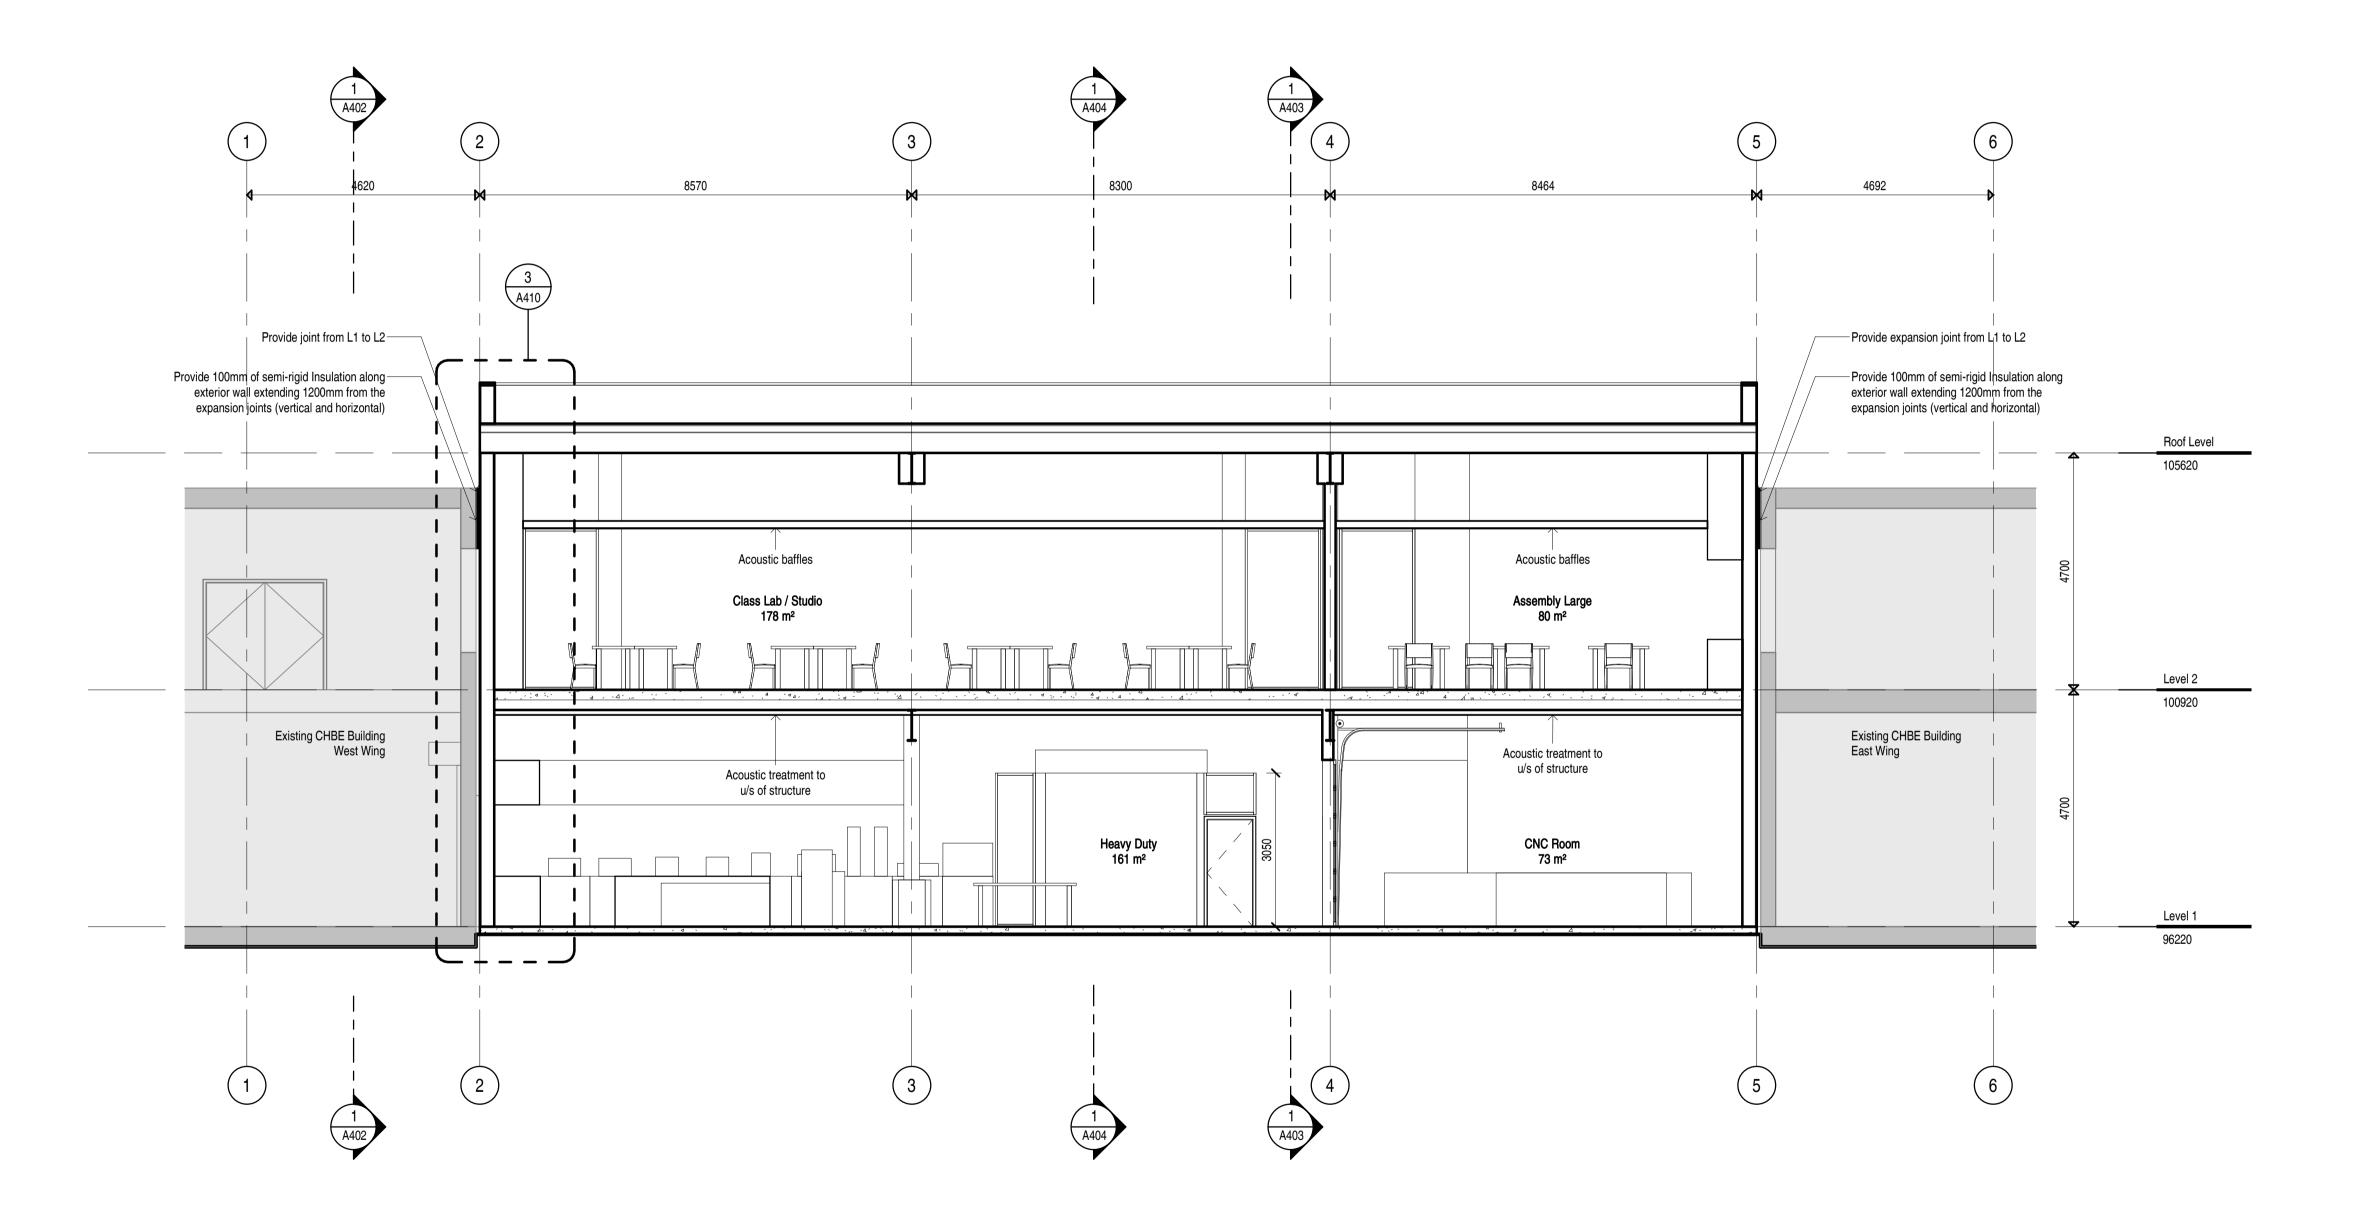
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Building Elevations

March 31 2023 DRAWN BY CHECKED BY AT/NS SCALE As indicated 2209 JOB NUMBER

General Notes - Section

1. In case of:
2.



Building Section Through Class Lab / Studios and Heavy Duty + CNC 1:75

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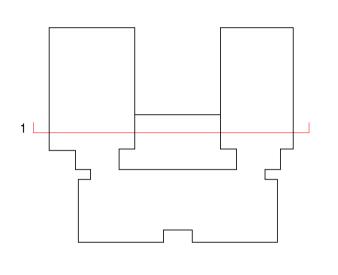
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Building Sections E-W

DATE March 31 2023
DRAWN BY WF
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SCALE As indicated

JOB NUMBER 2209

A400

General Notes - Section

1. In case of:
2.


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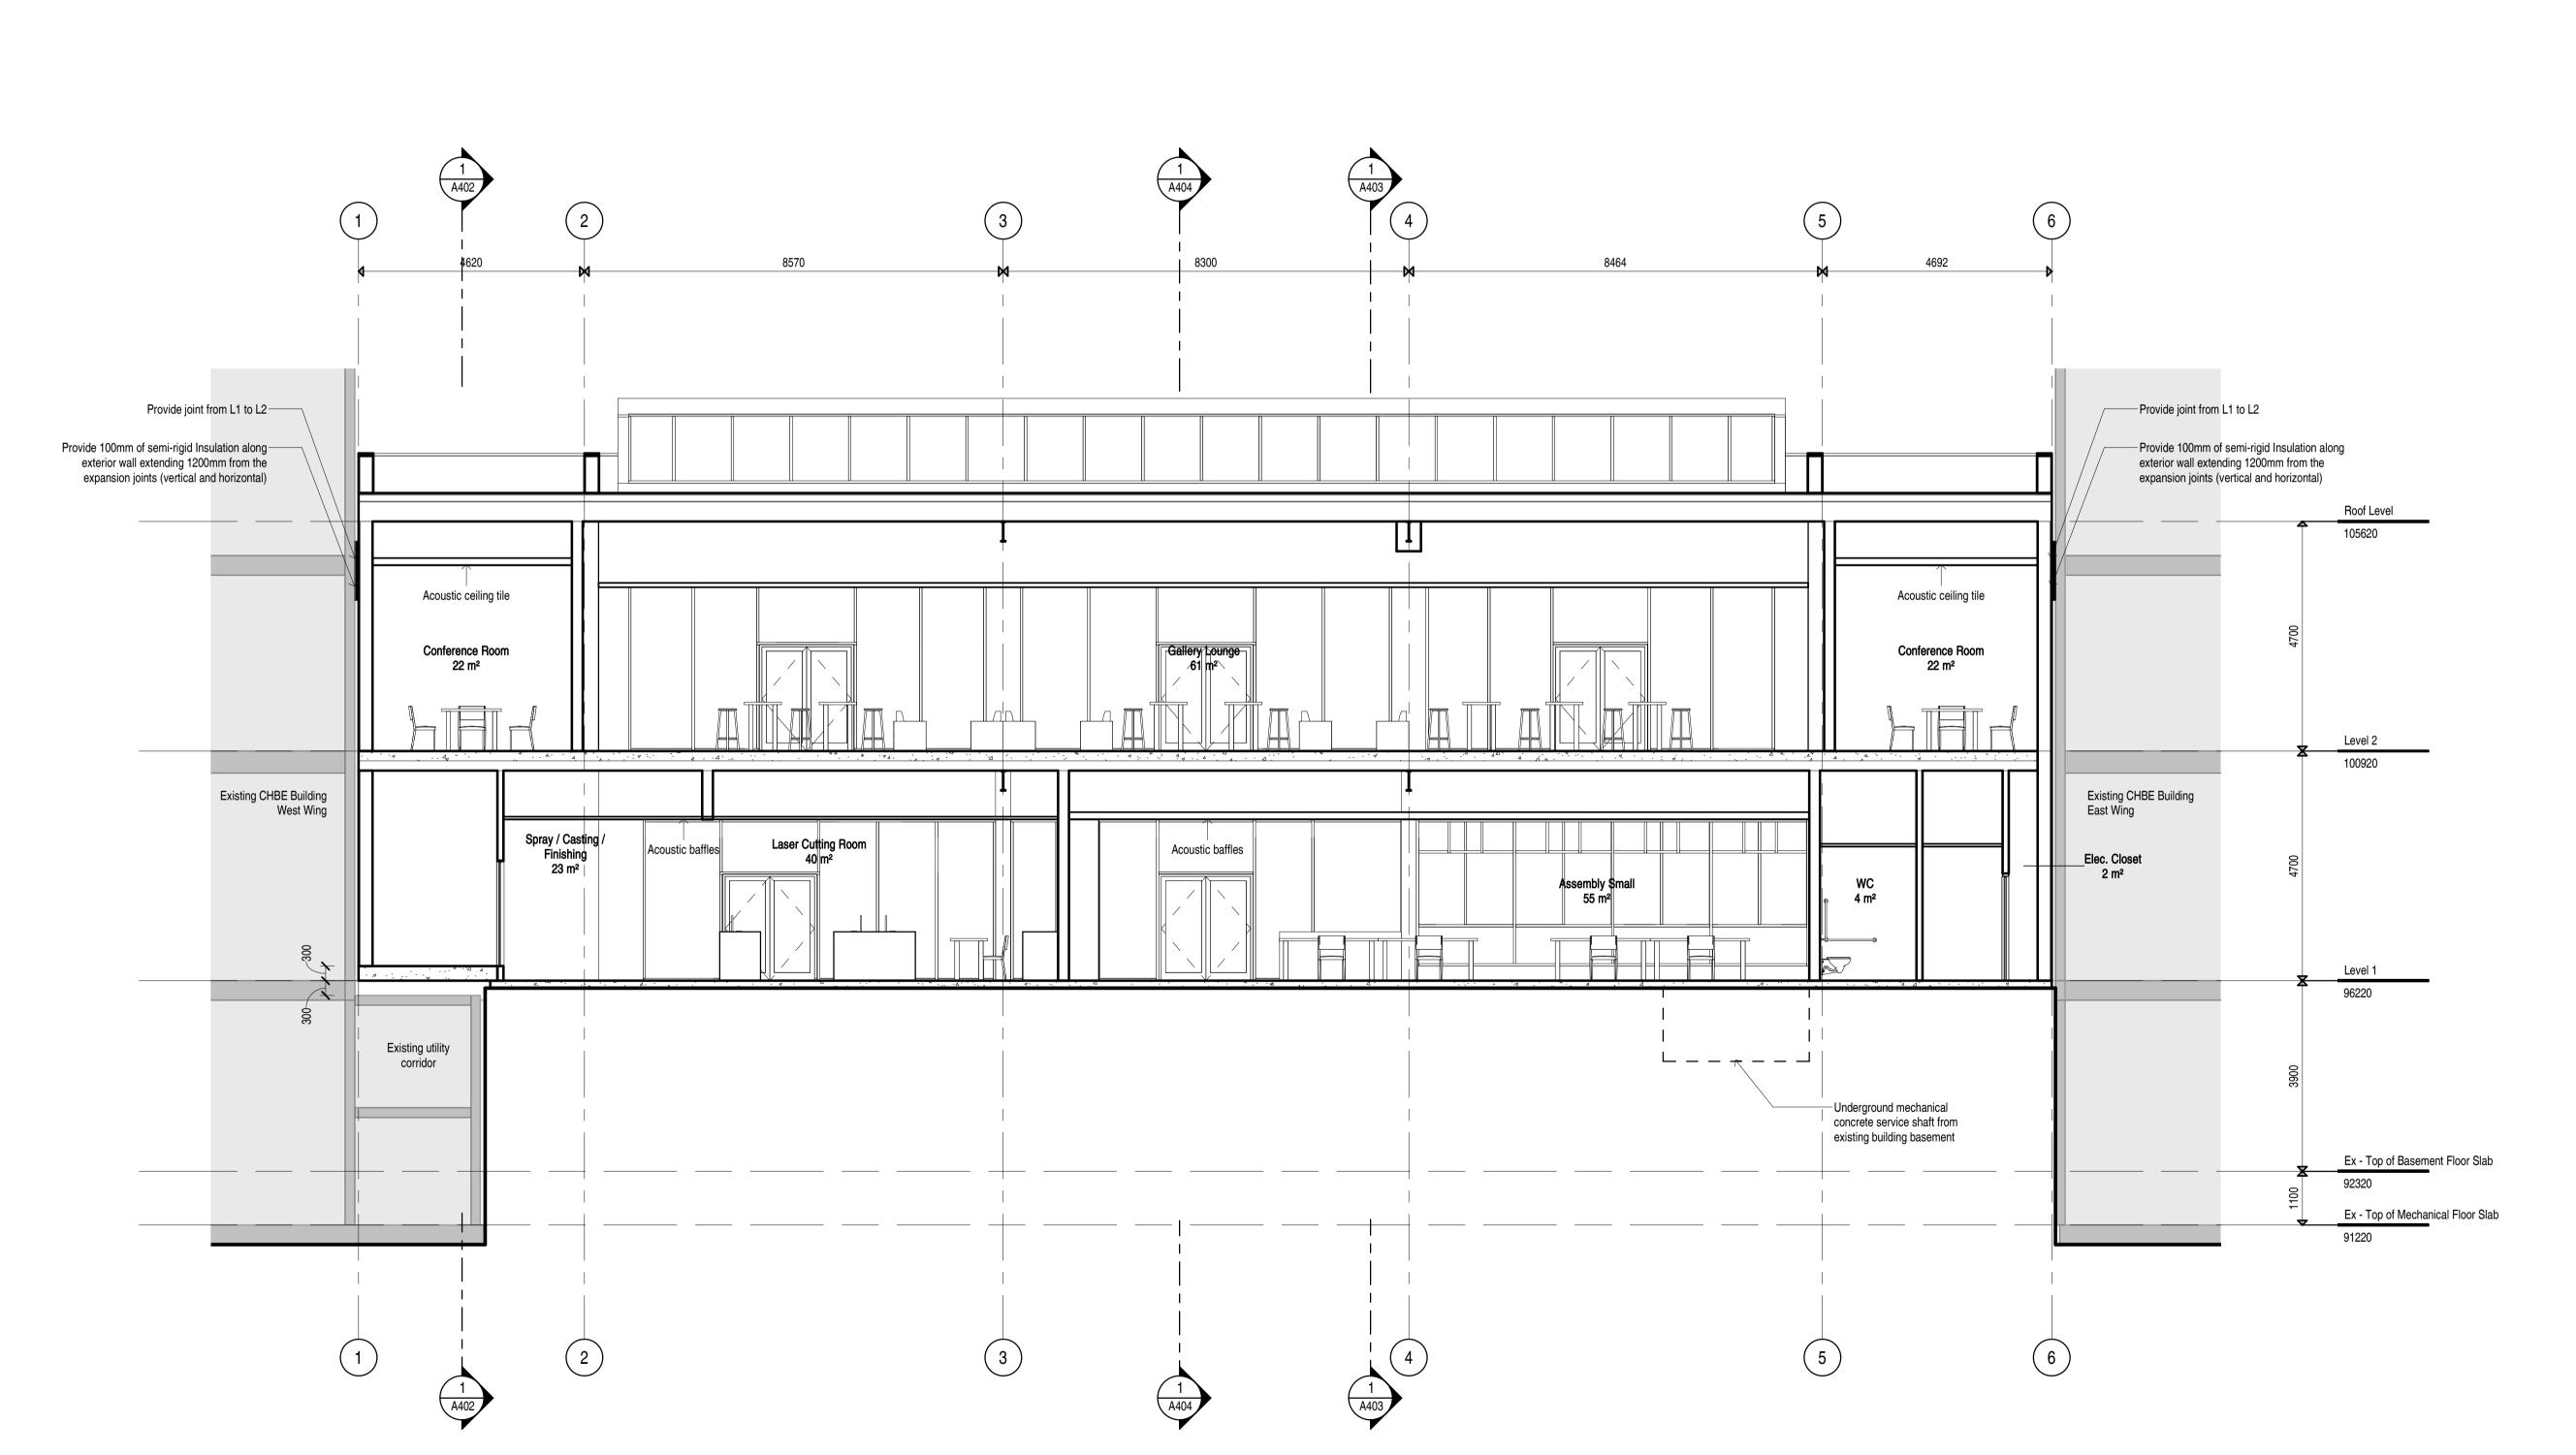
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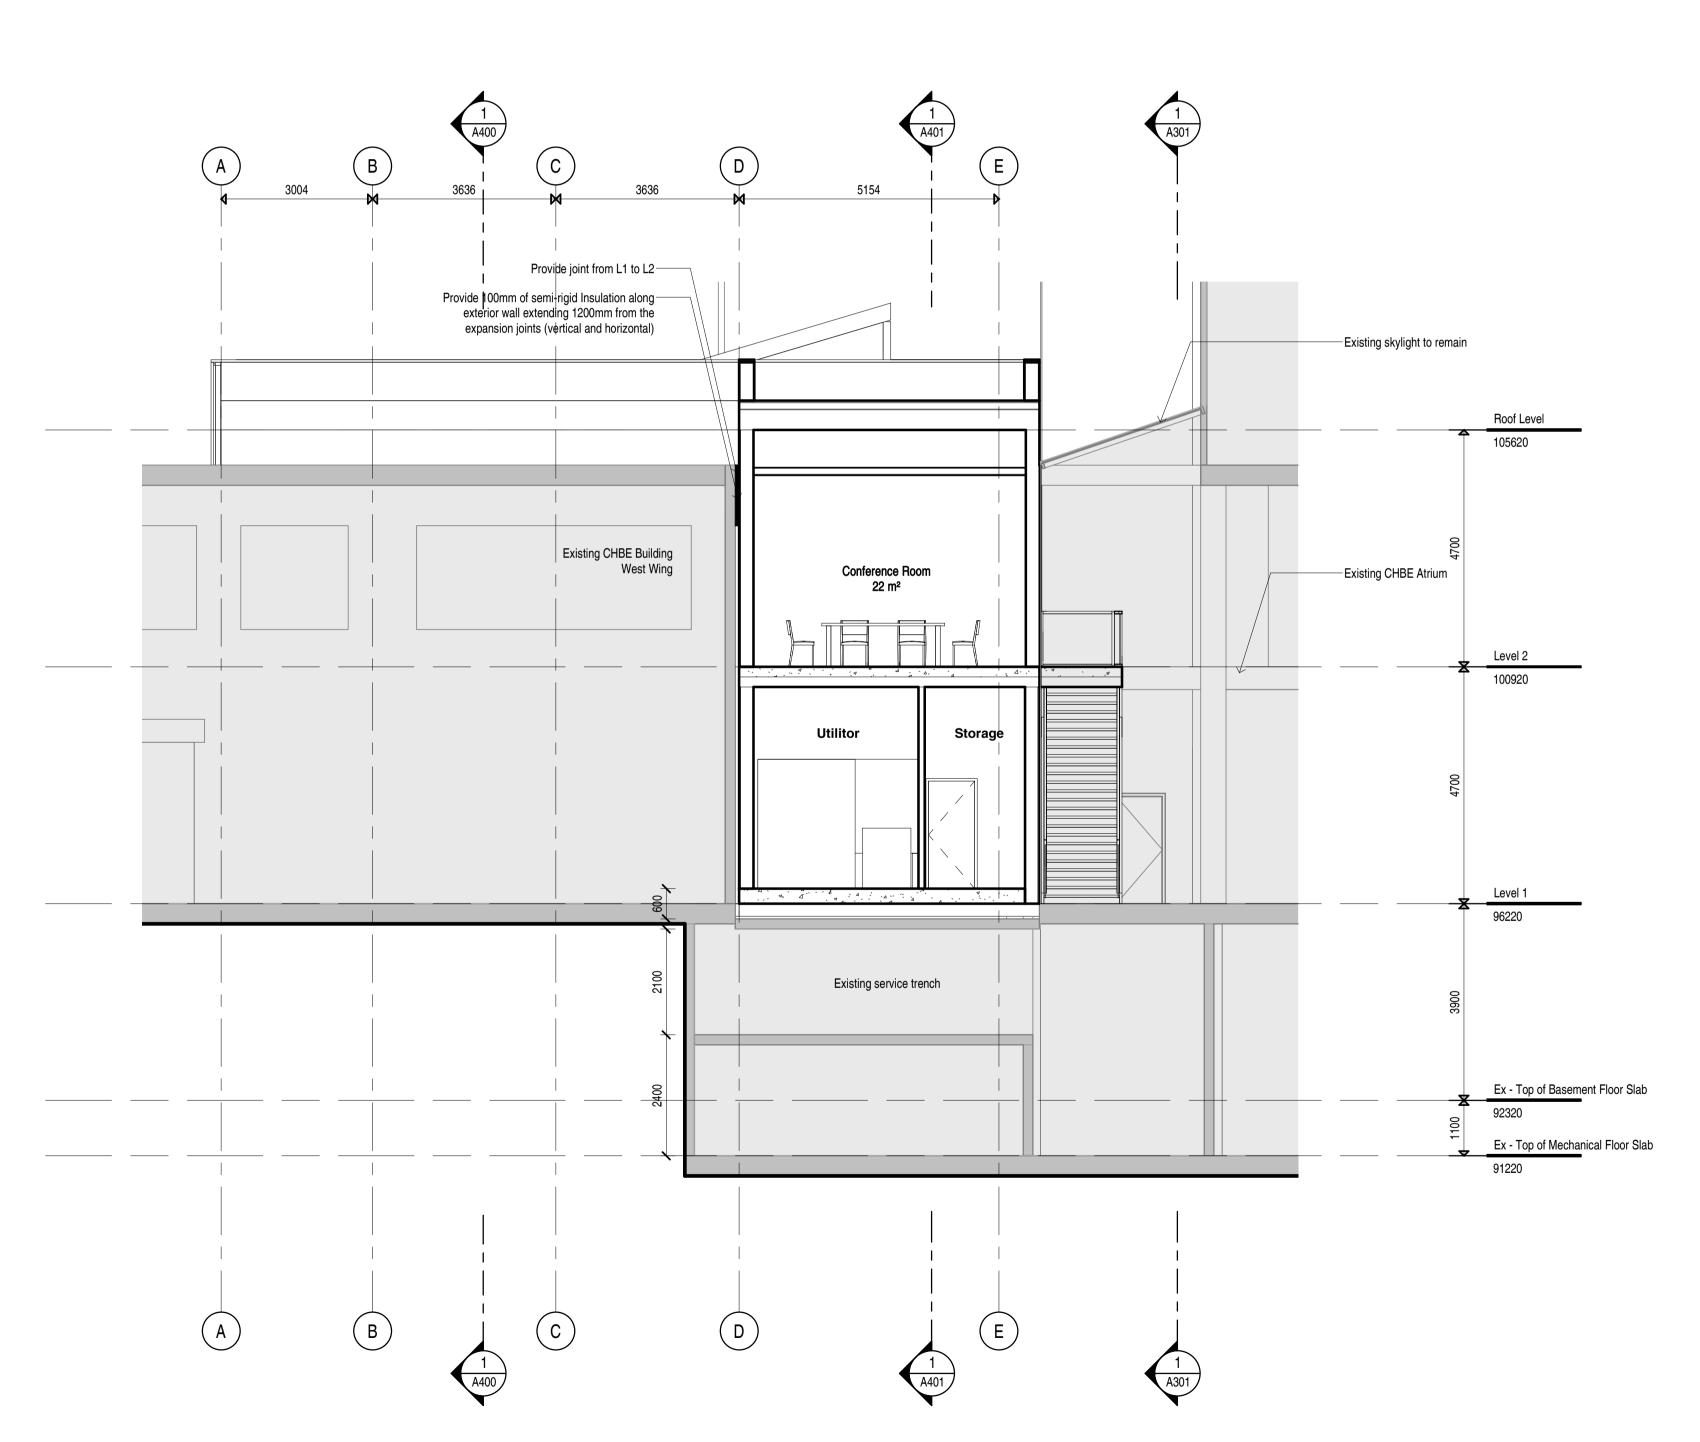
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Building Sections E-W

March 31 2023	DATE
WF	DRAWN BY
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As indicated	SCALE
2209	JOB NUMBER





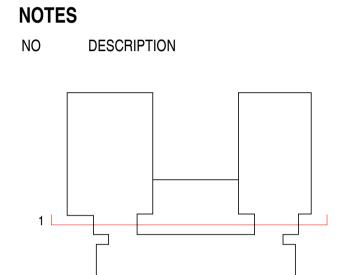

Building Section Through Virtual Conf. Room + Spray

1:75

General Notes - Section

1. In case of:

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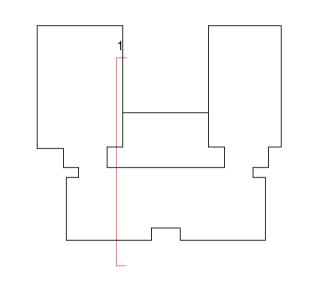
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Building Sections N-S


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DRAWN BY
CHECKED BY
SCALE

March 31 2023
WF
AT/NS
AT/NS
As indicated

JOB NUMBER

March 31 2023
WF
AT/NS
AT/NS
AS indicated

A402

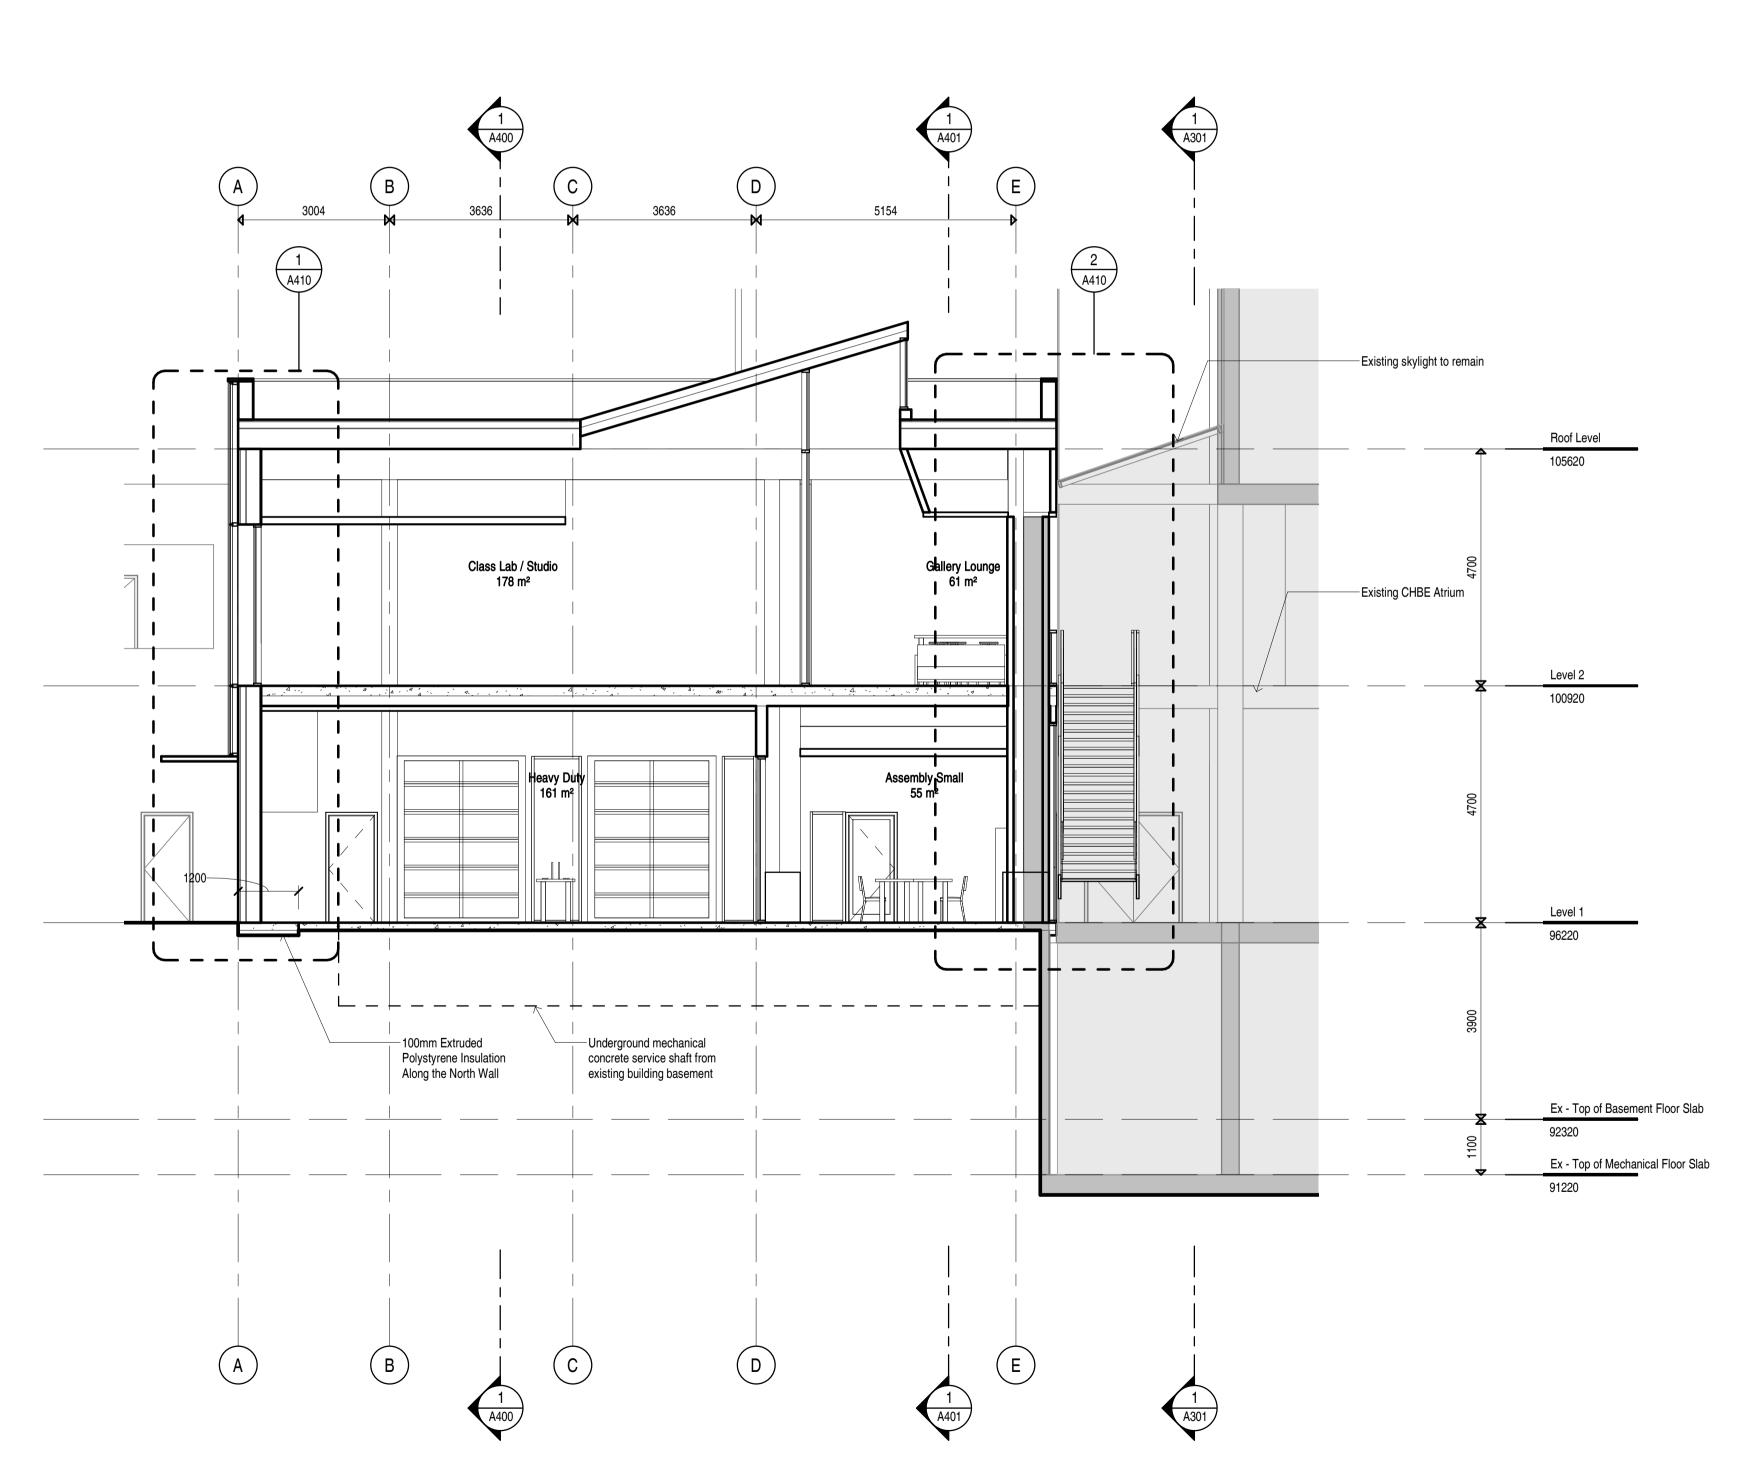

Building Section Through L2 Bridge 1:75

General Notes - Section

In case of:

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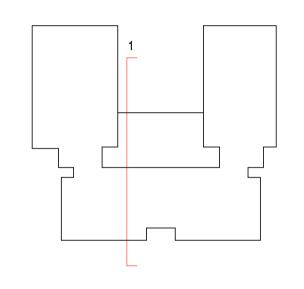
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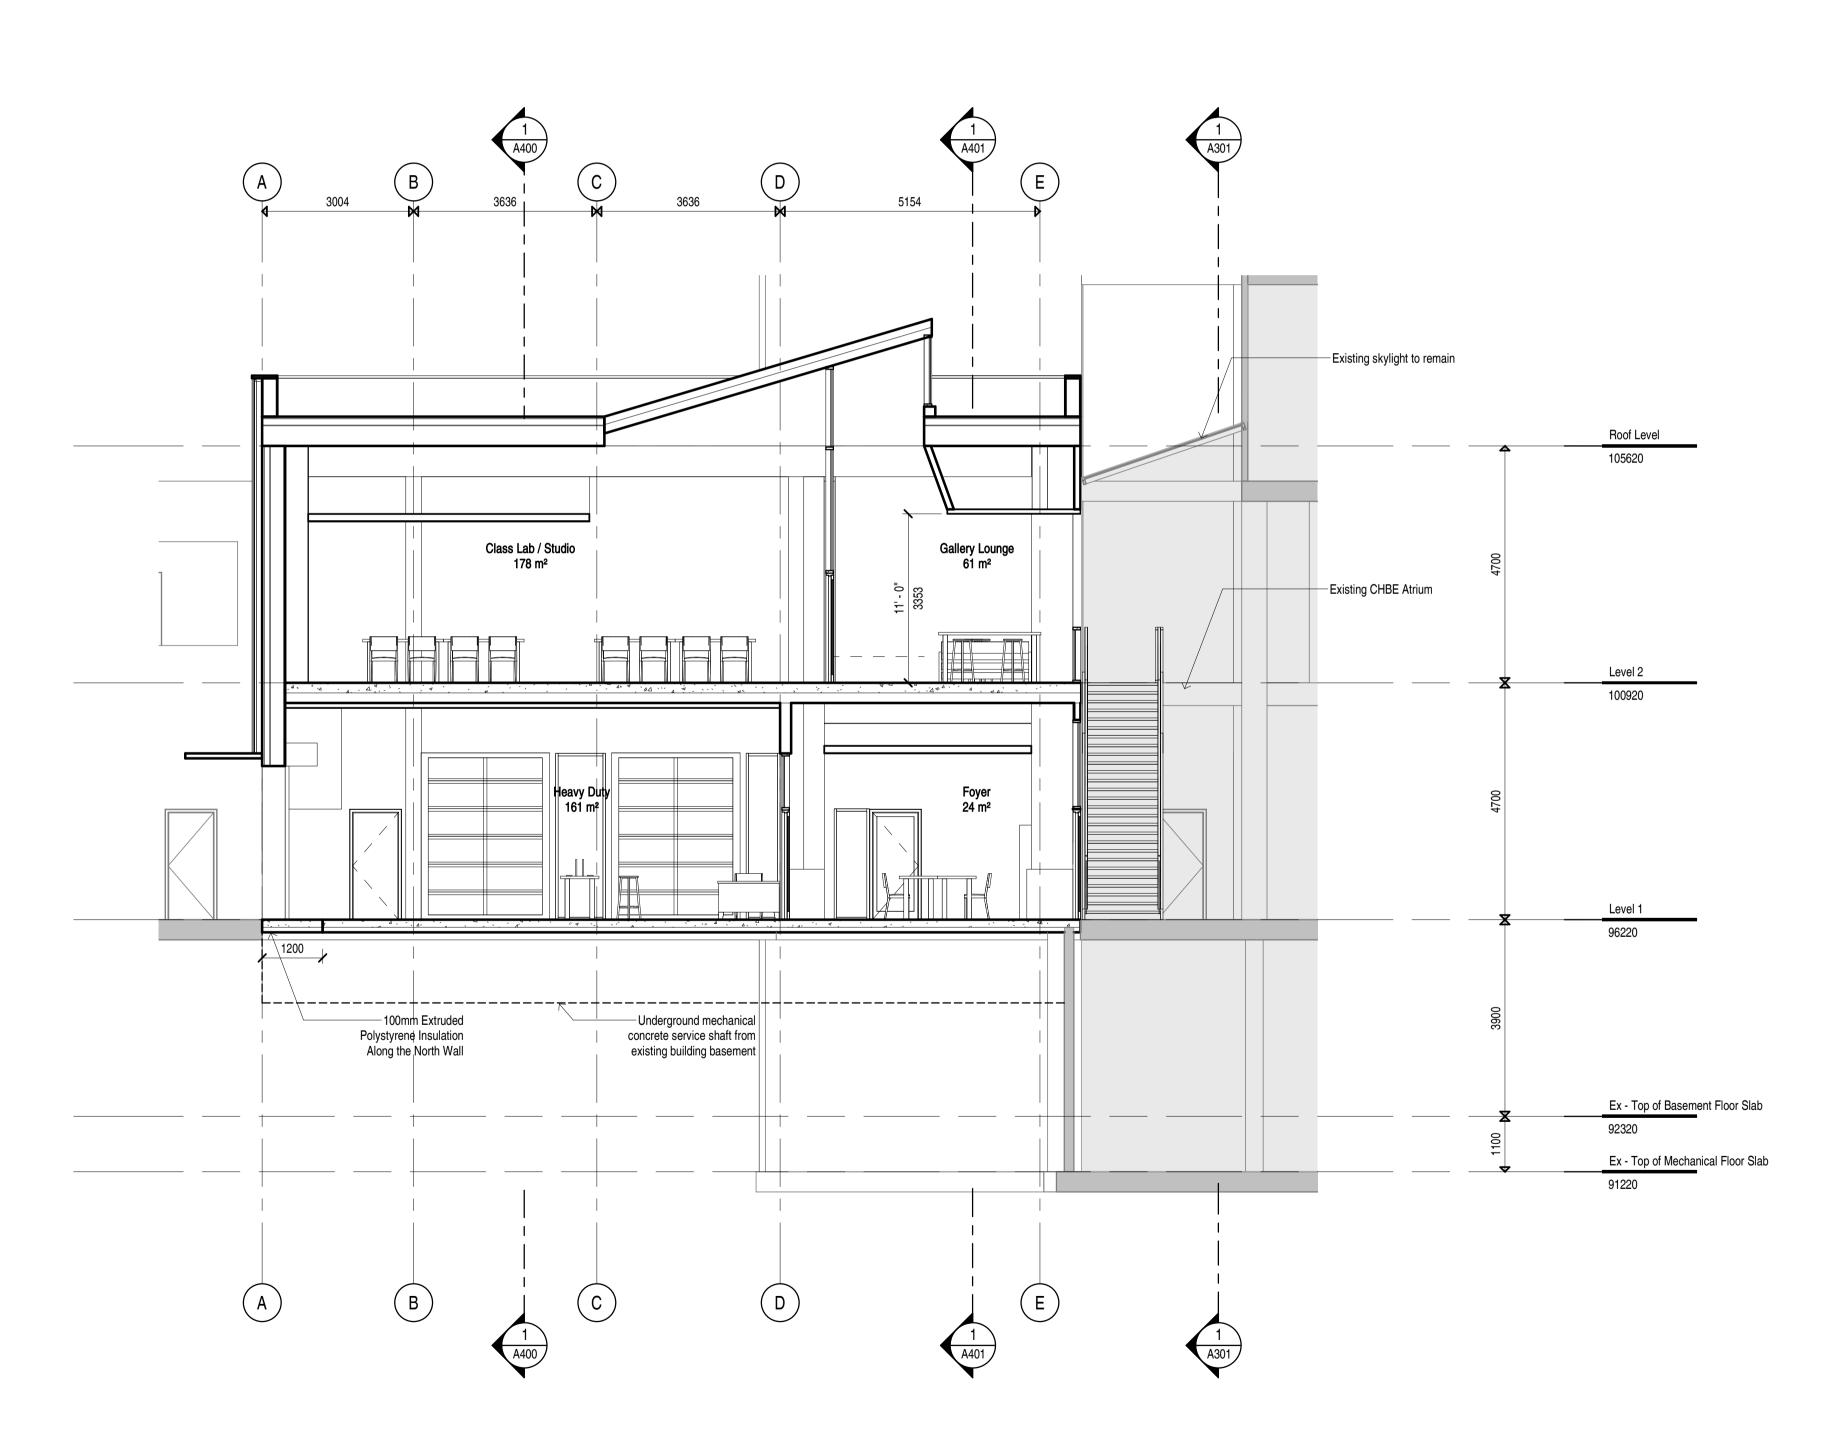
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Building Sections N-S

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Building Section Through South Entrance + Heavy Duty
1:75

General Notes - Section

In case of:

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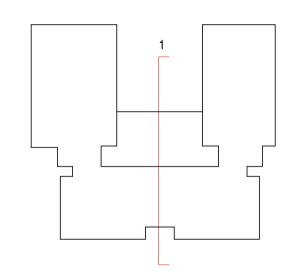
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Building Sections N-S

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